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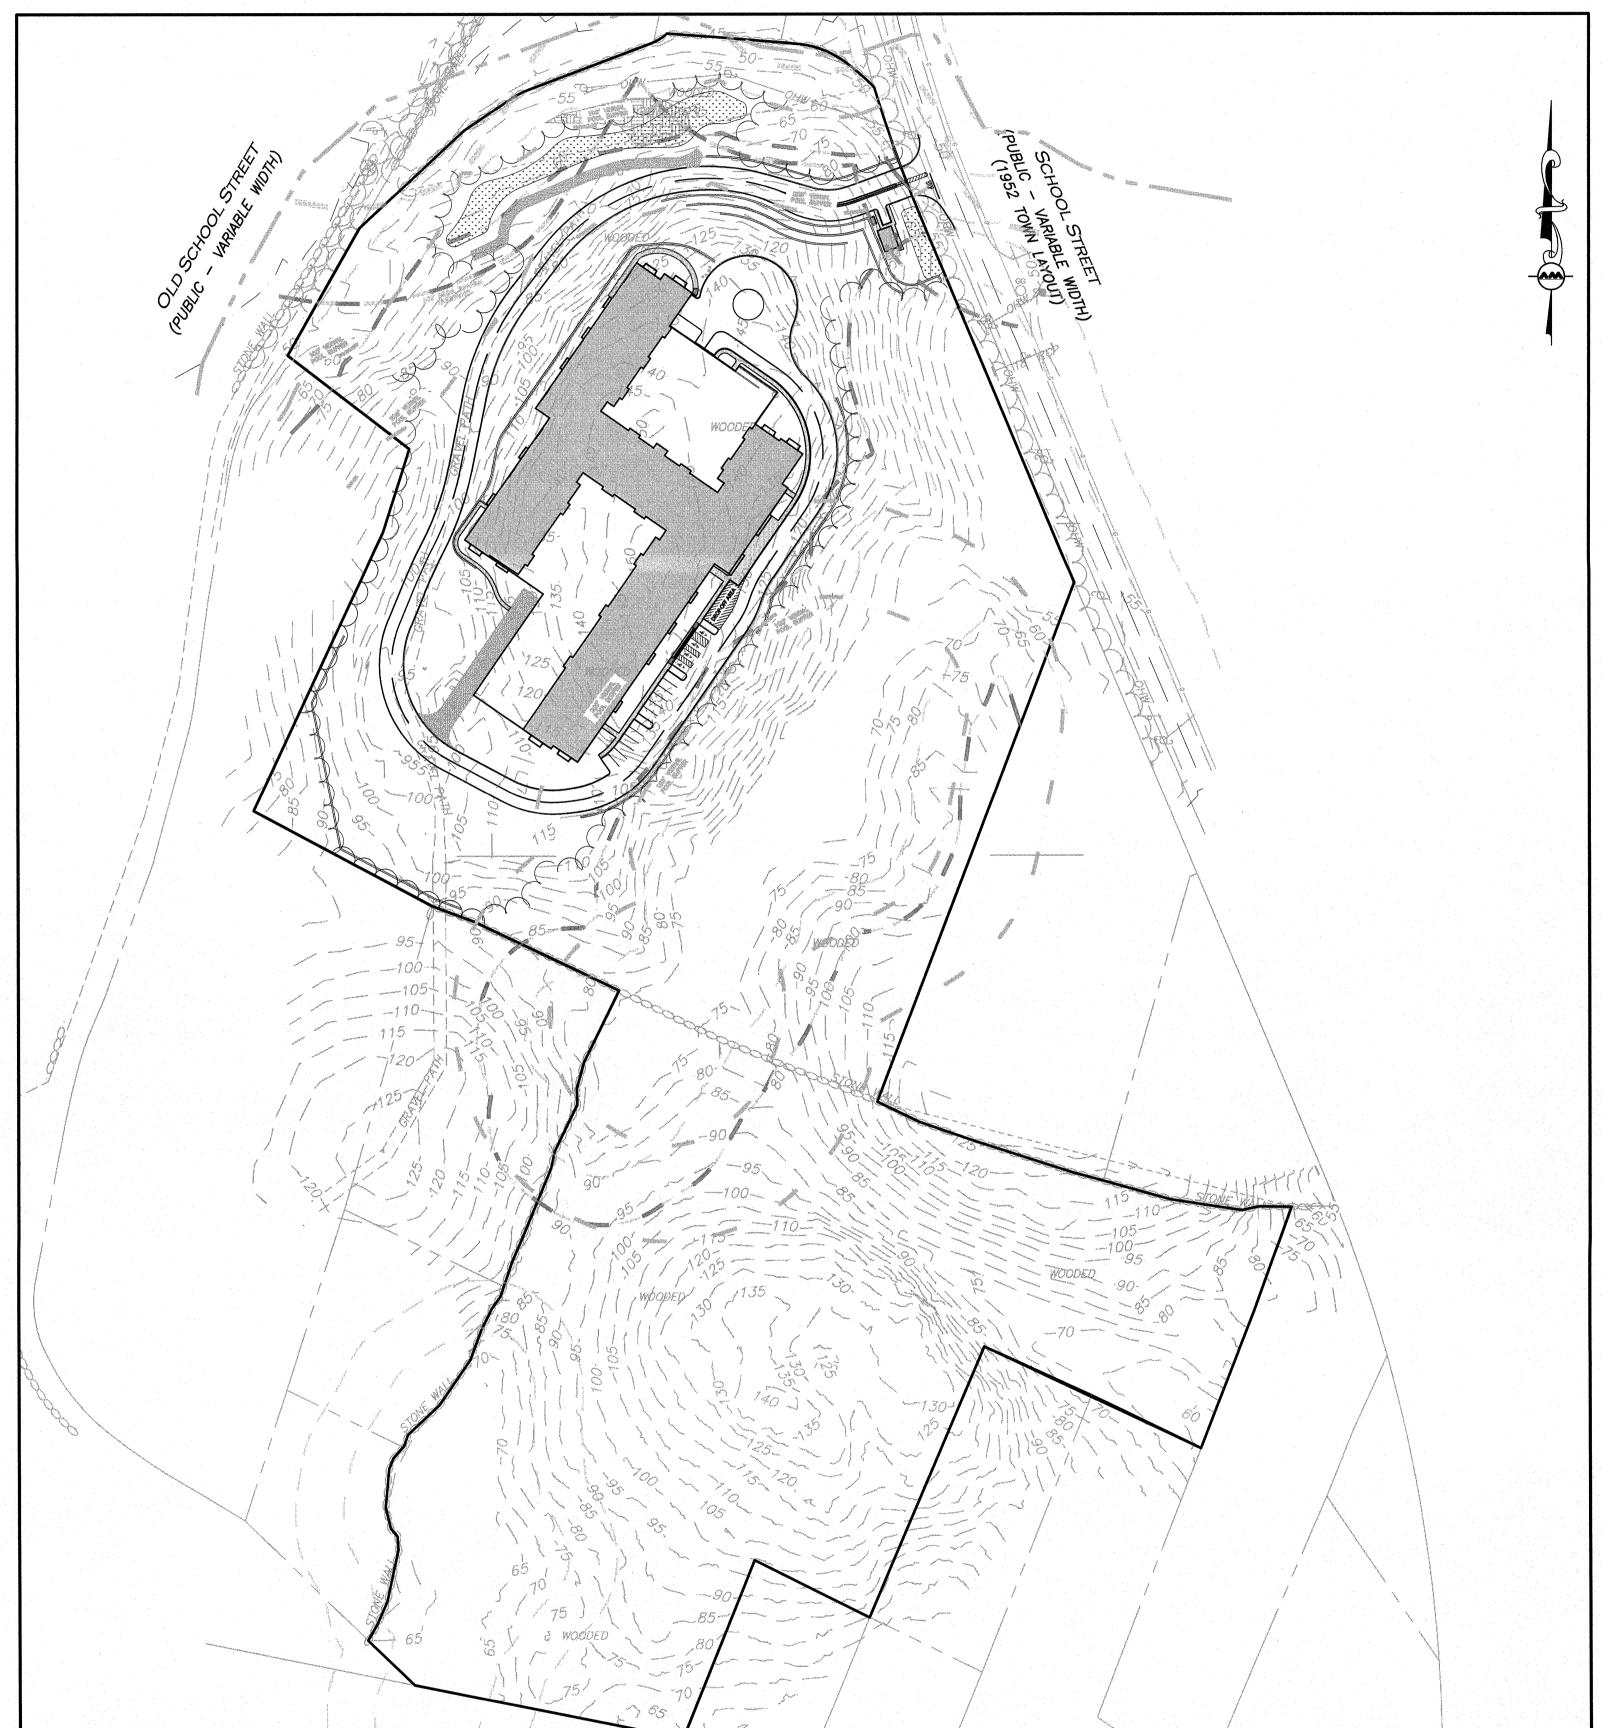
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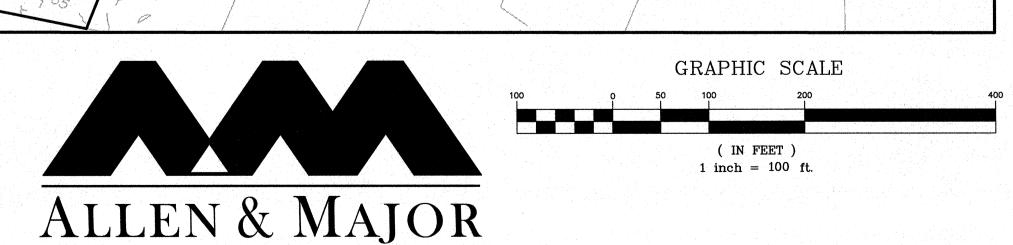
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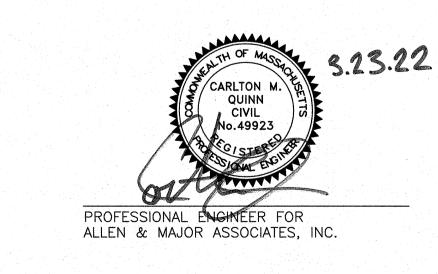
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SITE DEVELOPMENT PLANS FOR THE SANCTUARY SCHOOL STREET MANCHESTER-BY-THE-SEA, MA









ASSOCIATES, INC. civil & structural engineering • land surveying environmental consulting + landscape architecture www.allenmajor.com 100 COMMERCE WAY WOBURN MA 01801 SUITE 5

PREPARED BY

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CIVIL

DRAWING TITLE

ABBREVIATIONS & NOTES

EROSION CONTROL PLAN

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EXISTING CONDITIONS

GRADING PLAN

UTILITIES PLAN

TEST PIT PLAN

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ARCHITECTURAL COMP. PERMIT PLANS

NOTES

GENERAL NOTES:

- TOPOGRAPHIC INFORMATION AND EXISTING SITE FEATURES WERE OBTAINED FROM AN ACTUAL FIELD SURVEY PERFORMED BY ALLEN & MAJOR ASSOCIATES, INC, 100 COMMERCE WAY, WOBURN, MASSACHUSETTS. SEE EXISTING CONDITIONS PLAN FOR MORE INFORMATION.
- 2. ZONING DISTRICT IS LIMITED COMMERCIAL DISTRICT (LCD) AND THE WATER RESOURCE OVERLAY PROTECTION DISTRICT ZONE 3.
- 3. OVERALL LOT SIZE: 23.32± ACRES.
- . THIS SITE HAS AN ORDER OF RESOURCE AREA DELINEATION (ORAD DEP FILE #039-0834) CONFIRMING RESOURCE DELINATION UNDER THE STATE WETLANDS PROTECTION ACT. THE ORIGINAL ORAD HAS AN EXPIRATION DATE OF 5/25/2024.
- 5. DURING CONSTRUCTION, ALL STACING AND DELIVERIES WILL OCCUR ON
- DURING CONSTRUCTION, ALL STAGING AND DELIVERIES WILL OCCUR ON SITE.
- 7. THIS PROJECT WILL BE SERVED BY PUBLIC WATER AND SEWER AND PRIVATE NATURAL GAS, TELEPHONE, CABLE AND ELECTRIC. ALL UTILITY LINES WILL BE INSTALLED UNDERGROUND UNLESS OTHERWISE NOTED.
- THE CONTRACTOR IS SPECIFICALLY CAUTIONED THAT THE LOCATION AND/OR ELEVATION OF EXISTING UTILITIES AND STRUCTURES AS SHOWN ON THESE PLANS IS BASED ON RECORDS OF VARIOUS UTILITY COMPANIES AND WHERE POSSIBLE, MEASUREMENTS TAKEN IN THE FIELD. THIS INFORMATION IS NOT TO BE RELIED ON AS BEING EXACT OR COMPLETE. THE LOCATION OF ALL UNDERGROUND UTILITIES AND STRUCTURES SHALL BE VERIFIED IN THE FIELD BY THE CONTRACTOR PRIOR TO THE START OF CONSTRUCTION. THE CONTRACTOR MUST CONTACT THE APPROPRIATE UTILITY COMPANY, ANY GOVERNING PERMITTING AUTHORITY, AND "DIGSAFE" AT LEAST 72 HOURS PRIOR TO ANY EXCAVATION WORK TO REQUEST EXACT FIELD LOCATION OF UTILITIES AND THE ENGINEER SHALL BE NOTIFIED IN WRITING OF ANY UTILITIES INTERFERING WITH THE PROPOSED CONSTRUCTION AND APPROPRIATE REMEDIAL ACTION TAKEN BEFORE PROCEEDING WITH THE WORK. IT SHALL BE THE RESPONSIBILITY OF THE CONTRACTOR TO RELOCATE ALL EXISTING UTILITIES WHICH CONFLICT WITH THE PROPOSED IMPROVEMENTS SHOWN ON THE PLANS AT NO ADDITIONAL COST.
- 9. ALL PROPOSED MAIN BUILDING ENTRANCES AND WALKS SHALL BE HANDICAP ACCESSIBLE PER FEDERAL ADA & MA AAB REGULATIONS.
- 10. ALL SITE WORK DONE FOR THIS PROJECT SHALL BE IN STRICT ACCORDANCE WITH THE SITE PLANS AND SITE WORK SPECIFICATIONS FOR CONSTRUCTION. ONCE PROJECT SPECIFICATIONS ARE AVAILABLE, THE DPW SHALL BE ALLOWED TO REVIEW AND APPROVE THE DOCUMENT.
- 11. ANY DAMAGE TO PRIVATE OR PUBLIC PROPERTIES DUE TO THE CONTRACTOR'S ACTIVITIES SHALL BE REPAIRED AND RESTORED BY THE CONTRACTOR AT THEIR OWN EXPENSE.
- 12. ALL PROPERTY MARKERS AND STREET LINE MONUMENTS SHALL BE PROPERLY PROTECTED DURING CONSTRUCTION. ANY DAMAGE TO THESE ITEMS SHALL BE REPAIRED AND RESTORED BY A SURVEYOR REGISTERED IN THE STATE OF MASSACHUSETTS AT THE CONTRACTOR'S EXPENSE.
- 13. ALL APPLICABLE PERMITS AND AN APPROVED SET OF PLANS SHALL BE AVAILABLE AT THE CONSTRUCTION SITE.
- 14. THE CONTRACTOR IS RESPONSIBLE FOR SCHEDULING A PRE—CONSTRUCTION MEETING THE WITH THE APPROPRIATE TOWN DEPARTMENTS, THE APPROPRIATE UTILITY COMPANIES, THE OWNER AND OWNER'S REPRESENTATIVE. THE MEETING SHALL TAKE PLACE PRIOR TO THE START OF CONSTRUCTION AND THE CONTRACTOR MUST PROVIDE 48 HOURS NOTICE TO ALL ATTENDEES PRIOR TO THE START OF THE MEETING.
- 15. APPROPRIATE WARNING SIGNS, MARKERS, BARRICADES AND/OR FLAG MEN SHALL BE PROVIDED TO REGULATE TRAFFIC. CONSTRUCTION TRAFFIC CONTROLS SHALL BE IMPLEMENTED AND OPERATED ACCORDING TO THE MASS DEPARTMENT OF TRANSPORTATION, THE MANUAL ON UNIFORM TRAFFIC CONTROL DEVICES (MUTCD) AND THE LOCAL AUTHORITY. THE CONTRACTOR SHALL COORDINATE WITH THE MASS—DOT AND THE LOCAL POLICE DEPARTMENT REGARDING THE USE OF FLAG—MEN IN THE RIGHT—OF—WAY.
- 16. THE CONTRACTOR IS RESPONSIBLE FOR OBTAINING ADDITIONAL BENCHMARK INFORMATION IF REQUIRED. THE CONTRACTOR IS RESPONSIBLE FOR LOCATING AND PROTECTING ALL EXISTING BENCHMARKS. IF IT IS NECESSARY TO RELOCATE A BENCHMARK, IT SHALL BE RELOCATED BY A MASSACHUSETTS PROFESSIONAL LAND SURVEYOR AND DONE SO AT THE CONTRACTOR'S EXPENSE.
- 17. ALL BUILDING DIMENSIONS ARE MEASURED TO THE OUTSIDE FACE OF THE
- 18. ALL RADII ARE 3 FEET UNLESS OTHERWISE NOTED.
- 19. ALL PARKING LOT AND AISLE DIMENSIONS ARE TAKEN FROM THE FACE OF CURB AND INDICATE EDGE OF PAVEMENT.
- 20. CONSTRUCTION DURING WET WEATHER OR WINTER CONDITIONS IS TO BE ANTICIPATED AND PROVISIONS TO ADEQUATELY ADDRESS THESE CONDITIONS SHALL BE THE RESPONSIBILITY OF THE CONTRACTOR AT NO ADDITIONAL COST.
- 21. THE CONTRACTOR IS RESPONSIBLE FOR OBTAINING AND PAYING FOR ANY PERMITS AND/OR CONNECTION FEES REQUIRED TO CARRY OUT THE WORK INCLUDING BUT NOT LIMITED TO DEMOLITION.
- 22. DISPOSAL OF ALL DEMOLISHED MATERIALS INCLUDING EXISTING MISC. CONSTRUCTION DEBRIS IS THE RESPONSIBILITY OF THE CONTRACTOR AND MUST BE DISPOSED OF OFF—SITE IN ACCORDANCE WITH ALL FEDERAL, STATE, AND LOCAL MUNICIPAL REQUIREMENTS AT NO ADDITIONAL COST.
- 23. ALL DISTURBED AREAS NOT NOTED TO RECEIVE OTHER TREATMENT ARE TO RECEIVE SIX INCHES (6") MINIMUM OF TOPSOIL & SEED, AND BE MAINTAINED UNTIL ESTABLISHED & ACCEPTED.
- 24. EXISTING STRUCTURES WITHIN CONSTRUCTION LIMITS ARE TO BE PROTECTED, ABANDONED, REMOVED OR RELOCATED AS NECESSARY.
- 25. CONTRACTOR SHALL BE RESPONSIBLE FOR ALL RELOCATIONS, INCLUDING BUT NOT LIMITED TO, ALL UTILITIES, STORM DRAINAGE, SIGNS, & POLES, ETC. AS REQUIRED. ALL WORK SHALL BE IN ACCORDANCE WITH THE LOCAL MUNICIPALITY'S GOVERNING AUTHORITY'S SPECIFICATIONS AND SHALL BE APPROVED BY SAME.
- 26. THE CONTRACTOR SHALL COORDINATE WITH ALL UTILITY COMPANIES TO DETERMINE EXACT POINT OF SERVICE CONNECTION AND DISCONNECTION AT EXISTING UTILITY.

- 27. ALL ELEVATIONS SHOWN ARE IN REFERENCE TO THE BENCHMARKS SHOWN ON THE EXISTING CONDITIONS SITE PLAN AND MUST BE VERIFIED BY THE GENERAL CONTRACTOR AT GROUNDBREAKING.
- 28. CONTRACTOR IS RESPONSIBLE FOR DIGGING TEST HOLES AND VERIFYING ANY EXISTING UTILITY OR STRUCTURE PRIOR TO CONSTRUCTION.
 CONTRACTOR SHALL VERIFY THAT BASED ON EXACT LOCATION OF EXISTING UTILITIES, THERE ARE NO CONFLICTS BETWEEN THE EXISTING AND THE PROPOSED UTILITIES/DRAINAGE STRUCTURES.
- 29. THE CONTRACTOR SHALL ADHERE TO ALL PERMIT CONDITIONS PROVIDED BY ALL GOVERNING AGENCIES AT NO ADDITIONAL COSTS. THIS INCLUDES BUT IS NOT LIMITED TO BUILDING PERMITS, DEMOLITION PERMITS, PLUMBING, GAS, AND ELECTRICAL PERMITS. PERMITS FROM THE PLANNING BOARD OR TOWN COUNCIL.
- 30. DURING EXCAVATION, ANY EXISTING EARTH CUT MATERIALS THAT DO NOT MEET THE "ORDINARY FILL" SPECIFICATIONS OR "LOAM" SPECIFICATIONS AND CANNOT BE REUSED SHALL BE REMOVED OFFSITE BY THE CONTRACTOR AT NO ADDITIONAL COST TO THE OWNERS. MATERIAL WHICH DOES NOT MEET THE SPECIFICATION INCLUDES ALL BOULDERS, ROCKS, CONSTRUCTION DEBRIS, AND MISC. MATERIAL. PRIOR TO REUSE, CONTRACTOR TO PROVIDE TESTING REPORT OF SIEVE ANALYSIS TO ENGINEER FOR APPROVAL. CONTRACTOR CAN AMEND MATERIALS AND CONTINUE TO RETEST AS NECESSARY AT NO ADDITIONAL COST TO OWNER. AFTER AMENDING, IF MATERIAL STILL DOES NOT MEET THE SPECIFICATIONS, IT IS TO BE REMOVED FROM SITE AT NO ADDITIONAL COST TO THE OWNER AND IN ACCORDANCE WITH ALL FEDERAL, STATE, AND LOCAL LAWS AND REGULATIONS.
- 31. ANY PROPOSED SIGNAGE SHALL BE APPROVED BY SEPARATE APPLICATION TO THE APPROPRIATE MUNICIPAL AUTHORITY INCLUDING BUT NOT LIMITED TO THE ZONING BOARD OF APPEALS AND TOWN COUNCIL. ALL PROPOSED SIGNAGE MUST MEET THE REQUIREMENTS OF THE LOCAL ZONING CODE.

GRADING & DRAINAGE NOTES:

- EXISTING PAVEMENT SHALL BE SAW-CUT AND PAVEMENT JOINT SHALL BE INSTALLED WHERE NECESSARY TO ENSURE A SMOOTH CONTINUOUS GRADE.
- ALL GRADING OPERATIONS SHALL BE COORDINATED WITH THE APPROPRIATE UTILITY COMPANIES.
- 3. IN LANDSCAPED AREAS THE TOP ELEVATION OF ANY STRUCTURE (DRAIN MANHOLES, SEWER MANHOLES, CATCH BASINS, ETC.) SHALL MATCH THE FINISH GRADE OF THE TOPSOIL. IN PAVED AREAS THE TOP ELEVATIONS OF ANY STRUCTURE SHALL MATCH FINISH GRADE. STRUCTURES THAT ARE PART OF THE SEWER SYSTEM AND PARKING LOT DRAINAGE SHALL BE WATER—TIGHT TO PREVENT INFLOW.
- 4. ALL AREAS DISTURBED DURING CONSTRUCTION SHALL BE STABILIZED AS SOON AS POSSIBLE UPON COMPLETION OF CONSTRUCTION WORK IN THE
- 5. TEMPORARY TUBULAR BARRIER PROTECTION AND/OR SILT SACKS SHALL BE INSTALLED AND MAINTAINED AT EXISTING DRAINAGE STRUCTURES DURING CONSTRUCTION, TO PREVENT SEDIMENT LADEN RUNOFF FROM ENTERING THE DRAINAGE SYSTEM.
- CONTRACTOR IS RESPONSIBLE FOR DEMOLITION OF EXISTING STRUCTURES INCLUDING REMOVAL OF ANY EXISTING UTILITIES SERVING THE STRUCTURE PER DEMOLITION PLAN.
- 7. ALL CATCH BASINS, MANHOLES, INFILTRATION SYSTEMS, AND WATER QUALITY STRUCTURES ARE TO BE CLEANED TO REMOVE ALL CONSTRUCTION SILT AND DEBRIS PRIOR TO FINAL APPROVAL.
- 8. IF ANY EXISTING UTILITY STRUCTURES TO REMAIN ARE DAMAGED DURING CONSTRUCTION, IT SHALL BE THE CONTRACTOR'S RESPONSIBILITY TO REPAIR AND/OR REPLACE THE EXISTING STRUCTURE AS NECESSARY TO RETURN IT TO EXISTING CONDITIONS OR BETTER AT NO ADDITIONAL COST.
- 9. ALL STORM PIPES ENTERING STRUCTURES SHALL BE GROUTED TO ENSURE CONNECTION AT STRUCTURE IS WATERTIGHT.
- 10. ALL STORM DRAIN MANHOLES SHALL HAVE TRAFFIC BEARING RING & COVERS & SHALL BE LABELED "DRAIN".
- 11. THE CONTRACTOR SHALL ADHERE TO ALL TERMS & CONDITIONS AS OUTLINED IN THE GENERAL N.P.D.E.S. PERMIT FOR STORM WATER DISCHARGE ASSOCIATED WITH CONSTRUCTION ACTIVITIES.
- 12. CONTRACTOR SHALL ENSURE POSITIVE DRAINAGE AWAY FROM BUILDINGS FOR ALL NATURAL AND PAVED AREAS.
- 13. CONTRACTOR SHALL APPLY STABILIZATION FABRIC TO ALL SLOPES STEEPER THAN 3H:1V.
- 14. ALL DRAINAGE SYSTEM COMPONENTS SHALL CONFORM TO LOCAL REQUIREMENTS.

UTILITY NOTES:

- THE LATEST STANDARDS OF THE LOCAL MUNICIPALITY SHALL BE FOLLOWED WHEN INSTALLING ANY STORM DRAIN WORK. STORM DRAIN WORK WILL BE INSPECTED BY THE LOCAL GOVERNING AUTHORITY PERSONNEL AND ALL COSTS SHALL BE THE RESPONSIBILITY OF THE CONTRACTOR.
- 2. WHERE AN EXISTING UTILITY IS FOUND TO CONFLICT WITH THE PROPOSED WORK, THE LOCATION, ELEVATION AND SIZE OF THE UTILITY SHALL BE ACCURATELY DETERMINED WITHOUT DELAY BY THE CONTRACTOR, AND THE INFORMATION FURNISHED TO THE ENGINEER FOR RESOLUTION.
- 3. ABANDONED EXISTING UTILITIES AND UTILITIES TO BE ABANDONED SHALL EITHER BE ABANDONED IN PLACE AS NOTED OR SHALL BE REMOVED AND DISPOSED OF AS SPECIFIED. ALL UTILITIES SCHEDULED FOR ABANDONMENT OR REMOVAL AND DISPOSAL MUST BE COORDINATED BY THE CONTRACTOR WITH THE RESPECTIVE UTILITY OWNER. WHEN ABANDONED UTILITIES ARE TO BE LEFT IN PLACE, PLUG OR CAP THE ENDS OF THE CONDUITS AND PIPES. REMOVE ABANDONED UTILITY MANHOLES, JUNCTION BOXES AND SIMILAR STRUCTURES TO A MINIMUM DEPTH OF 4 FEET BELOW FINISHED GRADE AND PUNCTURE OR BREAK THE BOTTOM SLABS OF MANHOLES AND SIMILAR STRUCTURE TO ALLOW DRAINAGE. BACKFILL AND COMPACT EXCAVATIONS RESULTING FROM REMOVAL OF UTILITY FACILITATES, AS REQUIRED TO RESTORE THE ORIGINAL GRADE.
- 4. THE CONTRACTOR SHALL MAKE ARRANGEMENTS FOR THE ALTERATION AND ADJUSTMENTS OF NATURAL GAS, ELECTRIC, TELEPHONE AND ANY OTHER UTILITY BY THE UTILITY OWNER.
- THE CONTRACTOR SHALL USE THE FOLLOWING PIPE MATERIALS:
 DRAIN HDPE (HIGH DENSITY CORRUGATED POLYETHYLENE PIPE WITH SMOOTH INNER WALL), ASTM D2321 (UNLESS OTHERWISE SPECIFIED ON PLAN)

SEWER - PVC (POLYVINYL CHLORIDE), SDR 35

WATER — C.L.D.I. (CEMENT—LINED DUCTILE IRON)

- 8. BEFORE UTILITY WORK BEGINS, THE CONTRACTOR WILL COORDINATE WITH THE LOCAL MUNICIPALITY FOR THE APPROPRIATE PERMIT AND INSPECTION FEES.
- 9. A MINIMUM OF 10 FEET CLEAR HORIZONTALLY SHALL BE MAINTAINED BETWEEN WATER MAINS AND SANITARY SEWER MAINS AND/OR STORM DRAINS. WHENEVER CONDITIONS PREVENT A LATERAL SEPARATION OF 10 FEET TO A WATER MAIN, THE WATER MAIN SHALL BE LAID IN A SEPARATE TRENCH AND THE DIFFERENCE IN ELEVATION BETWEEN THE WATER MAIN AND THE SEWER MAIN SHALL BE AT LEAST 18 INCHES WHEN THE WATER UTILITY IS ABOVE THE SEWER UTILITY.
- 10. ALL FILL MATERIAL IS TO BE IN PLACE, AND COMPACTED BEFORE INSTALLATION OF PROPOSED UTILITIES.
- 11. CONTRACTOR SHALL NOTIFY THE UTILITY AUTHORITY'S INSPECTORS 72 HOURS BEFORE CONNECTING TO ANY EXISTING LINE.
- 12. MINIMUM TRENCH WIDTH SHALL BE 2 FEET.
- 13. CONTRACTOR SHALL MAINTAIN A MINIMUM OF 5'-0" COVER AND A MAXIMUM OF 8'-0" COVER ON ALL WATERLINES.
- 14. IN THE EVENT OF A VERTICAL CONFLICT BETWEEN WATERLINES, SANITARY LINES, STORM LINES AND GAS LINES (EXISTING AND PROPOSED), THE SANITARY LINE SHALL BE DUCTILE IRON PIPE WITH MECHANICAL JOINTS AT LEAST 10 FEET ON BOTH SIDES OF CROSSING, THE WATERLINE SHALL HAVE MECHANICAL JOINTS WITH APPROPRIATE THRUST BLOCKING AS REQUIRED TO PROVIDE A MINIMUM OF 18" CLEARANCE BETWEEN THE PIPES. WHERE THE WATERLINE IS LESS THAN THE 18" VERTICAL CLEARANCE AND MEETING 10' HORIZONTAL CLEARANCE CANNOT BE MET, THE WATER MUST BE WRAPPED IN A POLY WRAP AND ENCASED IN
- 15. WATER LINE SHALL BE WRAPPED IN A POLY—WRAP BEFORE BEING ENCASED IN CONCRETE TO ENSURE THAT THE CONCRETE DOES NOT CORRODE THE NEWLY INSTALLED WATER LINE. ALL CONCRETE FOR ENCASEMENTS SHALL HAVE A MINIMUM 28 DAY COMPRESSION STRENGTH OF 3000 P.S.I.
- 16. CONTRACTOR IS RESPONSIBLE FOR COMPLYING WITH THE SPECIFICATIONS OF THE LOCAL AUTHORITIES WITH REGARDS TO MATERIALS AND INSTALLATION OF THE WATER, SEWER, GAS AND ELECTRICAL AND TELECOMMUNICATIONS LINES.
- 17. ALL NECESSARY INSPECTIONS AND/OR CERTIFICATIONS REQUIRED BY CODES AND/OR UTILITY SERVICE COMPANIES SHALL BE PERFORMED PRIOR TO ANNOUNCED BUILDING POSSESSION AND THE FINAL CONNECTION OF SERVICE.
- 18. DRAWINGS DO NOT NECESSARILY SHOW ALL EXISTING UTILITIES.

ABBREVIATIONS

ABAN ADJ	ABANDON ADJUST	L LB LP	LENGTH LEACHING BASIN LIGHT POLE
B BC BIT BCB BLDG BM BOS BOW BRK BV&B BVW	BORING BOTTOM OF CURB BITUMINOUS BITUMINOUS CONCRETE BERM BUILDING BENCH MARK BOTTOM OF SLOPE BOTTOM OF WALL BRICK BUTTERFLY VALVE & BOX BORDERING VEGETATED WETLAND	MAT MAX MH MIN MISC MTD MW	MATERIAL MAXIMUM MANHOLE MINIMUM MISCELLANEOUS MOUNTED MONITORING WELL NORTH NOT IN CONTRACT
CATV CB CF CFS CI CL CLDI	CABLE TELEVISION CATCH BASIN CUBIC FEET CUBIC FEET PER SECOND CAST IRON (PIPE) CENTERLINE CEMENT LINED DUCTILE IRON (PIPE)	NO NTS OC OD OHW OVHD OW	NUMBER NOT TO SCALE ON CENTER OUTSIDE DIAMETER OVERHEAD WIRE OVERHEAD OBSERVATION WELL
CM CMP CO CONC CONST CONT CRD CPP CUL CY	CONSTRUCTION MANAGER CORRUGATED METAL PIPE CLEAN OUT CONCRETE CONSTRUCTION CONTRACTOR COORDINATE CORRUGATED POLYETHYLENE PIPE CULVERT CUBIC YARD	PC PCC PI PKG PL PLMB POC POT PRC PROP, P PT PVC	POINT OF CURVATURE PRECAST CONCRETE CURB POINT OF INTERSECTION PARKING PROPERTY LINE PLUMBING POINT ON CURVATURE POINT ON TANGENT POINT OF REVERSE CURVATURE PROPOSED POINT (OR POINT OF TANGENT) POLYVINYL CHLORIDE (PIPE)
DB DBL DEM DET DI DIA DIM DMH DW DWG DYCL	DISTRIBUTION BOX DOUBLE DEMOLISH DETENTION DUCTILE IRON (PIPE) DIAMETER DIMENSION DRAIN MANHOLE DOMESTIC WATER (OR DRY WELL) DRAWING DOUBLE YELLOW CENTERLINE	R&R R&S RCP RD RED RELOC REM RET ROW RR RWL RWY	REMOVE & RESET/REPLACE REMOVE & STACK REINFORCED CONCRETE PIPE ROAD (OR ROOF DRAIN) REDUCER RELOCATE REMOVE RETAIN, RETAINING OR RETENTION RIGHT OF WAY RAILROAD RAIN WATER LEADER ROADWAY
EHH EL ELEC EMH EOP EOR EOW ETC EXIST EXT	ELECTRIC HANDHOLE ELECTRIC ELECTRIC MANHOLE EDGE OF PAVEMENT EDGE OF ROAD EDGE OF WETLANDS ELECTRIC, TELEPHONE, CABLE EXISTING EXTERIOR	SD SF SGC SMH SP SPEC STA STC STD	SUBDRAIN SQUARE FEET SLOPED GRANITE CURB SEWER MANHOLE STANDPIPE SPECIFICATION STATION STORMCEPTOR STANDARD
FA FCC FES FFE FLNP FPS FS	FINISH FLOOR ELEVATION FIRE LANE NO PARKING FEET PER SECOND FIRE SERVICE	STRTL SWEL SW SWLL SYCL TB TC TD	SIDEWALK SOLID WHITE LANE LINE SOLID YELLOW CENTERLINE TEST BORING TOP OF CURB TRENCH DRAIN
GC GEN GG GR GRAN	GENERAL CONTRACTOR GENERAL GAS GATE GUIDE RAIL GRANITE	TEL, T TMH TOS TOW TP TS&V TYP	TELEPHONE TELEPHONE MANHOLE TOP OF SLOPE TOP OF WALL TEST PIT TAPPING SLEEVE & VALVE TYPICAL
GV GV&B GW	GATE VALVE GATE VALVE & BOX GROUND WATER	UD UL UP	UNDERDRAIN UNDERWRITERS LABORATORY UTILITY POLE
HCR HOR HT HW HWY HYD	HANDICAP RAMP HORIZONTAL HEIGHT HEADWALL HIGHWAY HYDRANT	VCP VERT VGC WD WG	VITRIFIED CLAY PIPE VERTICAL VERTICAL GRANITE CURB WOOD WATER GATE
ID IN INCL INST	INSIDE DIAMETER INCHES INCLUDE INSTALLED INVERT INVERT FLEVATION	WM WMH WSO	WATER GATE WATER MAIN WATER MANHOLE WATER SHUTOFF

INV. I.E. INVERT, INVERT ELEVATION

PROFESSIONAL ENGINEER FOR ALLEN & MAJOR ASSOCIATES, INC.

A 03-23-2022 REVISED PER COMMENTS
REV DATE DESCRIPTION

APPLICANT\OWNER:

SLV SCHOOL STREET, LLC
257 HILLSIDE AVENUE
NEEDHAM, MA 02494

PROJECT:

THE SANCTUARY
SCHOOL STREET
MANCHESTER-BY-THE-SEA, MA

PROJECT NO. 2725-01 DATE: 07-16-2021

SCALE: N/A DWG. NAME: C-2725-01

DESIGNED BY: CMQ/SJL CHECKED BY: CMQ



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ABBREVIATIONS & NOTES

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EROSION & SEDIMENTATION CONTROL NOTES:

- 1. EROSION CONTROL SHALL BE INSTALLED PRIOR TO CONSTRUCTION AND SHALL BE ADEQUATE TO MAINTAIN SEDIMENT ON SITE. ANY MODIFICATIONS TO SILT CONTROLS SHOWN ON THE APPROVED PLANS AS A RESULT OF ACTUAL FIELD CONDITIONS OR CONSTRUCTION PRACTICES SHALL BE INSTALLED IN ACCORDANCE WITH B.M.P. (BEST MANAGEMENT PRACTICES) PER THE E.P.A. 2017 "CONSTRUCTION GENERAL PERMIT" MANUAL, AND MASSACHUSETTS 2003 EROSION & SEDIMENT CONTROL GUIDELINES FOR URBAN AND SUBURBAN AREAS, ANY SUCH MODIFICATIONS FROM THE ABOVE MANUALS SHALL BE INSTALLED AS APPROVED BY THE ENGINEER OR THE LOCAL MUNICIPALITY.
- 2. AREAS OF EXPOSED SOIL UNDERGOING CONSTRUCTION THAT WILL NOT BE COVERED AND OR FINISHED GRADED SHALL BE STABILIZED AS SOON AS PRACTICABLE BUT IN NO CASE MORE THAN 14 DAYS AFTER THE CONSTRUCTION ACTIVITY (UNLESS MUNICIPALITY HAS STRICTER REQUIREMENTS WHICH SHALL BE FOLLOWED) IN THAT PORTION OF THE SITE HAS TEMPORARILY OR PERMANENTLY CEASED. TEMPORARY EROSION CONTROL MEASURES SHALL INCLUDE EROSION CONTROL MESH, NETTING OR MULCH AS DIRECTED BY THE OWNER'S REPRESENTATIVE AND SHOWN ON THE DESIGN PLANS. IF MULCH IS USED, STRAW MULCH SHALL BE APPLIED AT THE RATE OF 4 BALES PER 1,000 SQUARE FEET. APPLICATION AREA SHALL BE SUFFICIENTLY COVERED WITH MULCH TO AVOID ANY VISIBLE SOIL EXPOSURE. MULCH SHALL BE KEPT MOIST TO AVOID LOSS DUE TO WIND. MULCH AND NETTING SHALL BE APPLIED IN THE BASE OF ALL GRASSED WATERWAYS, IN VEGETATIVE SLOPES WHICH EXCEED 15% AND DISTURBED AREAS WITHIN 100 FEET OF WETLANDS OR STREAMS.
- 3. IF DISTURBED AREAS DO NOT RECEIVE FINAL SEEDING BY OCTOBER 1ST OF THE CONSTRUCTION YEAR, THEN ALL DISTURBED AREAS SHALL BE SEEDED WITH A WINTER COVER CROP AT THE RATE OF 3 LBS PER 1,000 SQUARE FEET. WINTER SEEDING SHALL BE COVERED WITH EROSION CONTROL MESH (MULCH AND NETTING). HEAVY GRADE MATS SHALL BE USED IN THE BASE OF ALL GRASSED WATERWAYS ON VEGETATED SLOPES IN EXCESS OF 15%, AND ANY DISTURBED AREAS WITHIN 100 FEET OF WETLANDS OR STREAMS. MULCH AND NETTING SHALL ALSO BE PROVIDED FOR ADDITIONAL WINTER PROTECTION.
- 4. ALL TOPSOIL SHALL BE COLLECTED, STOCKPILED, SEEDED WITH RYE AT 3LBS PER 1,000 SQUARE FOOT AND MULCHED, AND REUSED AS REQUIRED. TUBULAR BARRIERS SHALL BE PLACED DOWN GRADIENT FROM STOCKPILED LOAM. LOAM SHALL BE STOCKPILED AT LOCATIONS DESIGNATED BY THE OWNER AND ENGINEER.
- 5. ALL TUBULAR BARRIERS, SILT SACKS, AND EROSION CONTROL BERMS SHALL BE INSTALLED ACCORDING TO THE SITE PREPARATION PLAN. THESE SHALL BE MAINTAINED DURING DEVELOPMENT TO REMOVE SEDIMENT FROM RUNOFF WATER. ALL THE FILTER BARRIERS AND EROSION CONTROL BERMS SHALL BE INSPECTED AFTER ANY RAINFALL OR RUNOFF EVENT, MAINTAINED AND CLEANED UNTIL ALL AREAS HAVE AT LEAST 85-90% VIGOROUS PERENNIAL COVER OF GRASSES.
- 6. ADJACENT ROADS SHALL BE PERIODICALLY SWEPT OR WASHED TO AVOID TRACKING MUD, DUST OR DEBRIS FROM THE CONSTRUCTION AREA AS OFTEN AS NECESSARY (WHICH COULD BE ON A DAILY BASIS) TO REMOVE ANY SOIL OR SEDIMENTS AT NO ADDITIONAL COST TO THE OWNER. A WATERING TRUCK WILL BE USED TO PERIODICALLY SPRINKLE CONSTRUCTION AREAS IN ORDER TO KEEP THE LEVEL OF DUST TO A MINIMUM DURING THE DRY MONTHS AT NO ADDITIONAL COST TO THE OWNER.
- 7. THE CONTRACTOR SHALL USE EXTREME CAUTION TO AVOID ALLOWING SEDIMENTS TO ENTER THE STORM DRAIN SYSTEM DURING CONSTRUCTION. BOTH EXISTING AND PROPOSED CATCH BASIN INLETS SHALL BE PROTECTED DURING CONSTRUCTION BY THE USE SILT SACKS AND/OR TUBULAR BARRIERS AROUND EACH INLET AS NOTED ON THE PLANS. INLET PROTECTION MAY BE REMOVED ONLY AFTER FINISHED AREAS ARE PAVED AND THE VEGETATED SLOPES ARE ESTABLISHED WITH AT LEAST 85-90% OF VIGOROUS PERENNIAL GROWTH.
- 8. AS APPLICABLE, EROSION CONTROL MESH SHALL BE APPLIED IN ACCORDANCE WITH THE PLANS OVER ALL FINISHED SEEDED AREAS AS SPECIFIED ON THE DESIGN PLANS.
- 9. AT A MINIMUM, ALL TUBULAR BARRIERS AND FILTER FABRIC SHALL REMAIN IN PLACE UNTIL SEEDINGS OR PLANTINGS HAVE BECOME 85-90% ESTABLISHED. THE LOCAL CONSERVATION COMMISSION MUST APPROVE THE REMOVAL OR RELOCATION OF ANY OF THE TUBULAR BARRIERS AND FILTER FABRIC. ONCE THE TUBULAR BARRIERS ARE REMOVED THE AREAS ARE TO BE LOAMED AND SEEDED TO ACHIEVE FULL STABILIZATION.
- 10. AT THE OWNER'S DISCRETION ADDITIONAL EROSION CONTROL MEASURES MAY BE REQUIRED TO MAINTAIN STABILITY OF EARTHWORKS AND FINISHED GRADED AREAS. THE CONTRACTOR, AT HIS EXPENSE, WILL BE RESPONSIBLE FOR PROVIDING AND INSTALLING ANY ADDITIONAL MEASURES AS SPECIFIED BY THE OWNER. THIS INCLUDES BUT IS NOT LIMITED TO REQUESTS BY MA DEP, THE ENGINEER AND THE LOCAL MUNICIPALITY, AS AUTHORIZED BY THE OWNER. FAILURE TO COMPLY WITH THE OWNER'S DIRECTIONS WILL RESULT IN DISCONTINUATION OF CONSTRUCTION ACTIVITIES.
- 11. INSPECTIONS AND MONITORING MAINTENANCE MEASURES SHALL BE APPLIED AS NEEDED DURING THE ENTIRE CONSTRUCTION CYCLE. WEEKLY INSPECTIONS SHALL BE HELD THROUGH THE DURATION OF CONSTRUCTION ACTIVITY. WEEKLY INSPECTION REPORTS SHALL BE MAINTAINED BY THE CONTRACTOR AND LOCATED IN THE CONTRACTORS FIELD OFFICE ONSITE. IN ADDITION TO THE NORMAL WEEKLY INSPECTIONS, THE CONTRACTOR SHALL PERFORM AN INSPECTION OF ALL EROSION CONTROL MEASURES AFTER EACH RAINFALL OR RUNOFF EVENT, AND PERFORM THE NECESSARY REPAIRS. THE INSPECTIONS SHALL INCLUDE BUT NOT BE LIMITED TO THE SITE'S DOWN STREAM DISCHARGE POINTS.
- 12. IF ANY EVIDENCE OF SEDIMENTATION IS OBSERVED AT THE STORMWATER MANAGEMENT AREA INLETS, THE CONTRACTOR SHALL, AT HIS OWN EXPENSE, PROVIDE A PLAN TO THE ENGINEER TO REMOVE ANY ACCUMULATED SEDIMENT IN THESE AREAS. THE CONTRACTOR SHALL ALSO IMMEDIATELY PROVIDE ADDITIONAL ON SITE EROSION AND SEDIMENTATION CONTROL MEASURES TO PREVENT FURTHER DEGRADATION OF THE AREA.
- 13. FOLLOWING THE TEMPORARY OR FINAL SEEDINGS, THE CONTRACTOR SHALL INSPECT THE WORK AREA SEMI-MONTHLY TO ENSURE THE AREAS HAVE A MINIMUM OF 85-90% VEGETATED VIGOROUS GROWTH. RE-SEEDING SHALL BE CARRIED OUT BY THE CONTRACTOR WITH FOLLOW UP INSPECTIONS IN THE EVENT OF ANY FAILURES UNTIL VEGETATION IS ADEQUATELY ESTABLISHED.
- 14. CONTRACTOR & ALL SITE SUBCONTRACTORS SHALL BE FAMILIAR WITH & FOLLOW ALL APPROVED PERMITS AND CONDITIONS. CONTRACTOR SHALL MAINTAIN A COPY OF ALL APPROVED PERMITS ONSITE. ALL CONDITIONS & RECOMMENDATIONS WITHIN THE APPROVED PERMITS SHALL BE COMPLETED.
- 15. ALL EROSION MEASURES SHALL BE INSTALLED PRIOR TO CONSTRUCTION AND SHALL BE ADEQUATE TO MAINTAIN SEDIMENT ON SITE. ANY MODIFICATIONS SHALL BE INSTALLED AS DIRECTED BY THE ENGINEER OR THE LOCAL MUNICIPALITY.
- 16. EROSION AND SEDIMENTATION CONTROL MEASURES SHALL BE MAINTAINED DURING CONSTRUCTION, AND SHALL REMAIN IN PLACE UNTIL ALL SITE WORK IS COMPLETE AND GROUND COVER IS ESTABLISHED.
- 17. TOP OF STOCKPILES SHALL BE COVERED IN SUCH MANNER THAT STORMWATER DOES NOT INFILTRATE THE MATERIALS AND THEREBY RENDER THE SAME UNSUITABLE FOR FILL USE.

EROSION & SEDIMENTATION CONTROL NOTES (CONTINUED):

- 18. ALL DISTURBED OR EXPOSED AREAS SUBJECT TO EROSION SHALL BE STABILIZED WITH MULCH OR SEEDED FOR TEMPORARY VEGETATIVE COVER. NO AREA, SUBJECT TO EROSION SHALL BE LEFT DISTURBED AND UNSTABILIZED FOR PERIODS LONGER THAN IS ABSOLUTELY NECESSARY TO CARRY OUT THAT PORTION OF THE CONSTRUCTION WORK OR SIX MONTHS AFTER SOIL HAS BEEN DISTURBED WHICHEVER IS LESS.
- 19. CULVERT/PIPE INLETS AND OUTFALLS SHALL BE PROTECTED BY TUBULAR BARRIER FILTERS AND STONE CHECK DAMS UNTIL DISTURBED AREAS ARE PERMANENTLY
- 20. TUBULAR BARRIER DIKES SHALL BE CONSTRUCTED AT ALL EXISTING & PROPOSED CATCH BASINS. NO SEDIMENTATION SHALL ENTER THE ON—SITE OR OFF—SITE DRAINAGE SYSTEMS AT ANY TIME.
- 21. ALL EROSION CONTROL MEASURES SHALL BE ROUTINELY INSPECTED, CLEANED AND REPAIRED OR REPLACED AS NECESSARY THROUGHOUT ALL PHASES OF CONSTRUCTION. IN ADDITION, INSPECTIONS SHALL TAKE PLACE WEEKLY AND BEFORE AND AFTER EACH RAINFALL EVENT.
- 22. ALL PROPOSED SLOPES STEEPER THAN 3:1 SHALL BE STABILIZED WITH JUTE MESH AND PROTECTED FROM EROSION UNTIL WORK IS COMPLETE AND GROUND COVER IS ESTABLISHED.
- 23. THE CONTRACTOR SHALL KEEP ON SITE AT ALL TIMES ADDITIONAL TUBULAR BARRIERS FOR INSTALLATION AT THE DIRECTION OF THE ENGINEER OR THE TOWN ENGINEER TO MITIGATE ANY EMERGENCY CONDITION.
- 24. AS CONSTRUCTION DISTURBANCE IS GREATER THAN 1 ACRE, A NATIONAL POLLUTANT DISCHARGE ELIMINATION SYSTEM (NPDES) CONSTRUCTION GENERAL PERMIT NOI, AND STORM WATER POLLUTION PREVENTION PLAN (SWPPP) WILL NEED TO BE SUBMITTED TO THE EPA. THE NPDES PERMIT FOR STORM WATER DISCHARGE, & CONSTRUCTION GENERAL PERMIT NOI WILL BE REQUIRED TO BE SUBMITTED AT LEAST 14 DAYS PRIOR TO COMMENCING CONSTRUCTION BY THE CONTRACTOR. ALLEN & MAJOR WILL PREPARE AND SUBMIT SUBMIT THIS MATERIAL, ON BEHALF OF WP EAST ACQUISITIONS, LLC., PRIOR TO THE START OF CONSTRUCTION.
- 25. OWNER AND CONTRACTOR ARE RESPONSIBLE FOR COMPLIANCE WITH THE CONSTRUCTION GENERAL PERMIT NOI. WEEKLY SWPPP INSPECTION REPORTS TO BE PERFORMED BY CONTRACTOR. COPIES OF ALL SWPPP INSPECTION REPORTS SHALL BE PROVIDED TO THE LOCAL MUNICIPALITY, EPA, DEP, OR ANY OTHER AUTHORITY REQUESTING WITHIN 3 DAYS OF EACH INSPECTION.
- 26. APPLICABLE WORK AND MATERIALS SHALL COMPLY WITH ALL LOCAL, MA DEP, EPA CONSTRUCTION GENERAL PERMIT STANDARDS. ALL CONSTRUCTION SHALL CONFORM TO THE APPLICABLE SITE PLAN REGULATIONS FROM THE LOCAL AND USDA SOIL CONSERVATION SERVICE VEGETATIVE PRACTICES IN SITE DEVELOPMENT.
- 27. A WATERING TRUCK SHALL BE USED TO PERIODICALLY SPRINKLE CONSTRUCTION AREAS IN ORDER TO KEEP THE LEVEL OF DUST TO A MINIMUM DURING THE DRY MONTHS AND AS REQUIRED.
- 28. IF DEWATERING IS NECESSARY IT SHALL ONLY BE COMPLETED AS FOLLOWS: THE DISCHARGE SHALL BE STOPPED IMMEDIATELY IF THE RECEIVING AREA SHOWS ANY SIGN OF INSTABILITY OR EROSION. ALL CHANNELS, SWALES, AND DITCHES DUG FOR DISCHARGING WATER FROM THE EXCAVATED AREA SHALL BE STABLE PRIOR TO DIRECTING DISCHARGE TO THEM. IF A CONSTRUCTION EQUIPMENT BUCKET IS USED, IT SHALL EMPTY THE MATERIAL TO A STABLE AREA. NO DEWATERING SHALL OCCUR DURING PERIODS OF INTENSE, HEAVY RAIN. FLOW TO THE SEDIMENT REMOVAL STRUCTURE SHALL NOT EXCEED THE STRUCTURE'S CAPACITY TO SETTLE AND FILTER FLOW OR ITS VOLUME CAPACITY. WHENEVER POSSIBLE, THE DISCHARGE FROM THE SEDIMENT REMOVAL STRUCTURE SHALL DRAIN TO A WELL—VEGETATED BUFFER BY SHEET FLOW WHILE MAXIMIZING THE DISTANCE TO THE NEAREST WATER RESOURCE AND MINIMIZING THE SLOPE OF THE BUFFER AREA. THERE SHALL BE NO DIRECT DISCHARGE TO EXISTING WETLANDS OR STREAMS. ALL DISCHARGE SHALL BE IN COMPLIANCE WITH STATE, LOCAL, AND FEDERAL REQUIREMENTS.
- 29. INITIATE STABILIZATION OF EXPOSED AREAS IMMEDIATELY IF CONSTRUCTION WORK TEMPORARILY OR PERMANENTLY CEASES.
- 30. ALL DISCHARGES FROM POLLUTION SOURCES ARE PROHIBITED ONSITE SUCH AS FUELS, WASTEWATER FROM WASH OUT OF CONCRETE, WASTEWATER FROM CLEAN OUT OF PAINTS, FORM RELEASE OILS, SOLVENTS, ADHESIVES, CURING COMPOUNDS, POLLUTANTS USED FOR MAINTENANCE OF VEHICLES AND EQUIPMENT, SOAPS & SOLVENTS, TOXIC OR HAZARDOUS SUBSTANCES, CHEMICALS AND OILS. IF A POLLUTANT IS DISCHARGED IT NEEDS TO BE IMMEDIATELY CLEANED UP BY REMOVING THE CHEMICAL AND AFFECTED SOIL OR AREA OF SPILL FROM THE SITE IN ACCORDANCE WITH BOTH THE MANUFACTURER RECOMMENDATIONS, FEDERAL, STATE, AND LOCAL REQUIREMENTS. DO NOT HOSE DOWN AND SPREAD SPILLED ITEM. ALL CHEMICALS USED ON THE SITE SHALL BE IN LEAK—PROOF CONTAINERS STORED AWAY FROM WETLANDS, SURFACE WATERS, STORMWATER INLETS, AND DRAINAGE MEASURES. SPILL KITS SHALL BE AVAILABLE ONSITE FOR EMERGENCY USE. THERE SHALL BE A SECONDARY CONTAINMENT MEASURE OF ALL CHEMICALS IN ADDITION TO SPILL—PROOF CONTAINERS.
- 31. PRIOR TO COMMENCEMENT OF CONSTRUCTION, APPLICABLE CONTRACTOR PERSONNEL MUST HAVE AN UNDERSTANDING OF THE EPA CONSTRUCTION GENERAL PERMIT REQUIREMENTS AND THEIR SPECIFIC RESPONSIBILITIES UNDER THE PERMIT. AT A MINIMUM, PERSONNEL MUST BE TRAINED AND UNDERSTAND THE FOLLOWING: LOCATION OF ALL STORMWATER CONTROLS AND HOW TO MAINTAIN THEM, PROCEDURES FOR COMPLYING WITH THE POLLUTION PREVENTION REQUIREMENTS. PROCEDURES FOR CONDUCTING INSPECTIONS, RECORDING FINDINGS, AND TAKING CORRECTIVE ACTION.
- 32. ALL SEDIMENT TRACKED ONTO ROADWAYS MUST BE REMOVED AT END OF EACH WORK DAY.
- 33. ALL USE OF CATIONIC TREATMENT CHEMICALS (EXAMPLES INCLUDE POLYMERS, CHITOSAN, CATIONIC PAM, FLOCCULANTS OR OTHER CHEMICAL UTILIZED FOR STABILIZATION) ARE PROHIBITED. IF ALL OTHER AVAILABLE STABILIZATION MEASURES ARE NOT POSSIBLE AND USE OF CATIONIC CHEMICALS IS ABSOLUTELY NECESSARY THE CONTRACTOR WILL NEED TO CONTACT THE EPA NEW ENGLAND OFFICE IN WRITING FOR APPROVAL AND SPECIFIC REQUIREMENTS (MAXIMUM DOSAGE RATE, RESIDUAL TESTING, SPECIFIC LIMITATIONS, ETC) PRIOR TO USE.
- 34. IF USING NON-VEGETATIVE STABILIZATION MEASURES, IT MUST BE COMPLETED NO LATER THAN 14 DAYS AFTER INITIATING STABILIZATION. ALL AREAS OF EXPOSED SOILS MUST BE COVERED.
- 35. INSPECTIONS OF EROSION CONTROL MEASURES SHALL BE AT LEAST ONCE EVERY 7 DAYS BY THE CONTRACTOR. AT A MINIMUM INSPECTIONS SHALL INCLUDE ALL DISTURBED AREAS, ALL STORMWATER CONTROLS AND POLLUTION PREVENTION MEASURES, ALL LOCATIONS WHERE STABILIZATION MEASURES HAVE BEEN IMPLEMENTED, EQUIPMENT AND MATERIAL STORAGE AREAS, ALL AREAS WHERE STORMWATER FLOWS AND ALL POINTS OF DISCHARGE. WHEN CORRECTIVE ACTIONS ARE REQUIRED, THE CONTRACTOR MUST IMMEDIATELY TAKE ALL STEPS TO PREVENT POLLUTANT DISCHARGES UNTIL A PERMANENT SOLUTION IS IMPLEMENTED. AS NECESSARY NEW OR MODIFIED CONTROLS MUST BE INSTALLED AND OPERATIONAL, THE REPAIR MUST BE COMPLETED WITHIN 7 DAYS FROM THE TIME OF DISCOVERY. WITHIN 24 HOURS OF A TRIGGERING CONDITION OCCURRING THAT REQUIRES A CORRECTIVE ACTION, A CORRECTIVE ACTION REPORT MUST BE COMPLETED.

EROSION CONTROL NOTES

MAINTENANCE:

NEEDED.

ALL MEASURES STATED ON THE STORMWATER POLLUTION PREVENTION PLANS, SHALL BE MAINTAINED IN FULLY FUNCTIONAL CONDITION BY CONTRACTOR UNTIL NO LONGER REQUIRED FOR A COMPLETED PHASE OF WORK OR FINAL STABILIZATION OF THE SITE. ALL EROSION AND SEDIMENTATION CONTROL MEASURES SHALL BE CHECKED BY A QUALIFIED PERSON IN ACCORDANCE WITH THE CONTRACT DOCUMENTS OR THE APPLICABLE PERMIT, WHICHEVER IS MORE STRINGENT, AND REPAIRED IN ACCORDANCE WITH THE FOLLOWING:


- 1. INLET PROTECTION DEVICES AND BARRIERS SHALL BE REPAIRED OR REPLACED IF THEY SHOW SIGNS OF UNDERMINING, OR DETERIORATION.
- 2. ALL SEEDED AREAS SHALL BE CHECKED REGULARLY TO SEE THAT A HEALTHY STAND OF GRASS IS MAINTAINED. AREAS SHOULD BE FERTILIZED, WATERED, AND RESEEDED AS
- 3. ALL SEDIMENT CONTROLS SHALL BE REPAIRED TO THEIR ORIGINAL CONDITIONS IF DAMAGED. SEDIMENT SHALL BE REMOVED FROM THE TUBULAR SEDIMENT CONTROLS WHEN IT REACHES HALF THE HEIGHT OF THE CONTROL MEASURE OR AS REQUESTED BY THE OWNER OR ENGINEER.
- 4. THE CONSTRUCTION ENTRANCES SHALL BE MAINTAINED IN A CONDITION WHICH WILL PREVENT TRACKING OR FLOW OF MUD ONTO PUBLIC RIGHTS—OF—WAY. THIS MAY REQUIRE PERIODIC TOP DRESSING OF THE CONSTRUCTION ENTRANCES AS CONDITIONS DEMAND.
- 5. THE TEMPORARY PARKING AND STORAGE AREA SHALL BE KEPT IN GOOD CONDITION (SUITABLE FOR PARKING AND STORAGE). THIS MAY REQUIRE PERIODIC TOP DRESSING OF THE TEMPORARY PARKING AS CONDITIONS DEMAND.
- 6. OUTLET STRUCTURES IN THE SEDIMENTATION BASINS SHALL BE MAINTAINED IN OPERATIONAL CONDITIONS AT ALL TIMES. SEDIMENT SHALL BE REMOVED FROM SEDIMENT BASINS OR TRAPS WHEN THE DESIGN CAPACITY HAS BEEN REDUCED BY 50%.

CONSTRUCTION GENERAL PERMIT NOTES AND NARRATIVE:

NARRATIVE: THE STORMWATER POLLUTION PREVENTION PLANS CONSIST OF THE SITE PREPARATION PLAN TOGETHER WITH AN EXISTING CONDITIONS PLANS, GRADING PLANS, ABBREVIATIONS AND NOTES SHEETS, AND DETAIL SHEETS.

THE EROSION CONTROL PLAN WILL BE IMPLEMENTED TO:

- A. TREAT EROSION AS SOON AS POSSIBLE AFTER DISTURBANCE.
- B. PREVENT SEDIMENT FROM LEAVING THE CONSTRUCTION AREA AND ENTERING THE RECEIVING WATERS.
- C. CONSTRUCTION ACTIVITIES SHALL BE SCHEDULED TO MINIMIZE EROSION.
- D. ONLY DISTURB, CLEAR, OR GRADE AREAS NECESSARY FOR CONSTRUCTION.

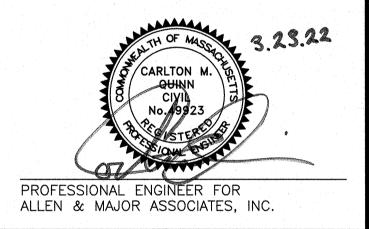

A 03-23-2022 REVISED PER COMMENTS
REV DATE DESCRIPTION

APPLICANT\OWNER:

SLV SCHOOL STREET, LLC 257 HILLSIDE AVENUE NEEDHAM, MA 02494

PROJECT:

THE SANCTUARY
SCHOOL STREET
MANCHESTER-BY-THE-SEA, MA

 PROJECT NO.
 2725-01
 DATE:
 07-16-2021

 SCALE:
 N/A
 DWG. NAME:
 C-2725-01

 DESIGNED BY:
 CMQ/SJL
 CHECKED BY:
 CMQ



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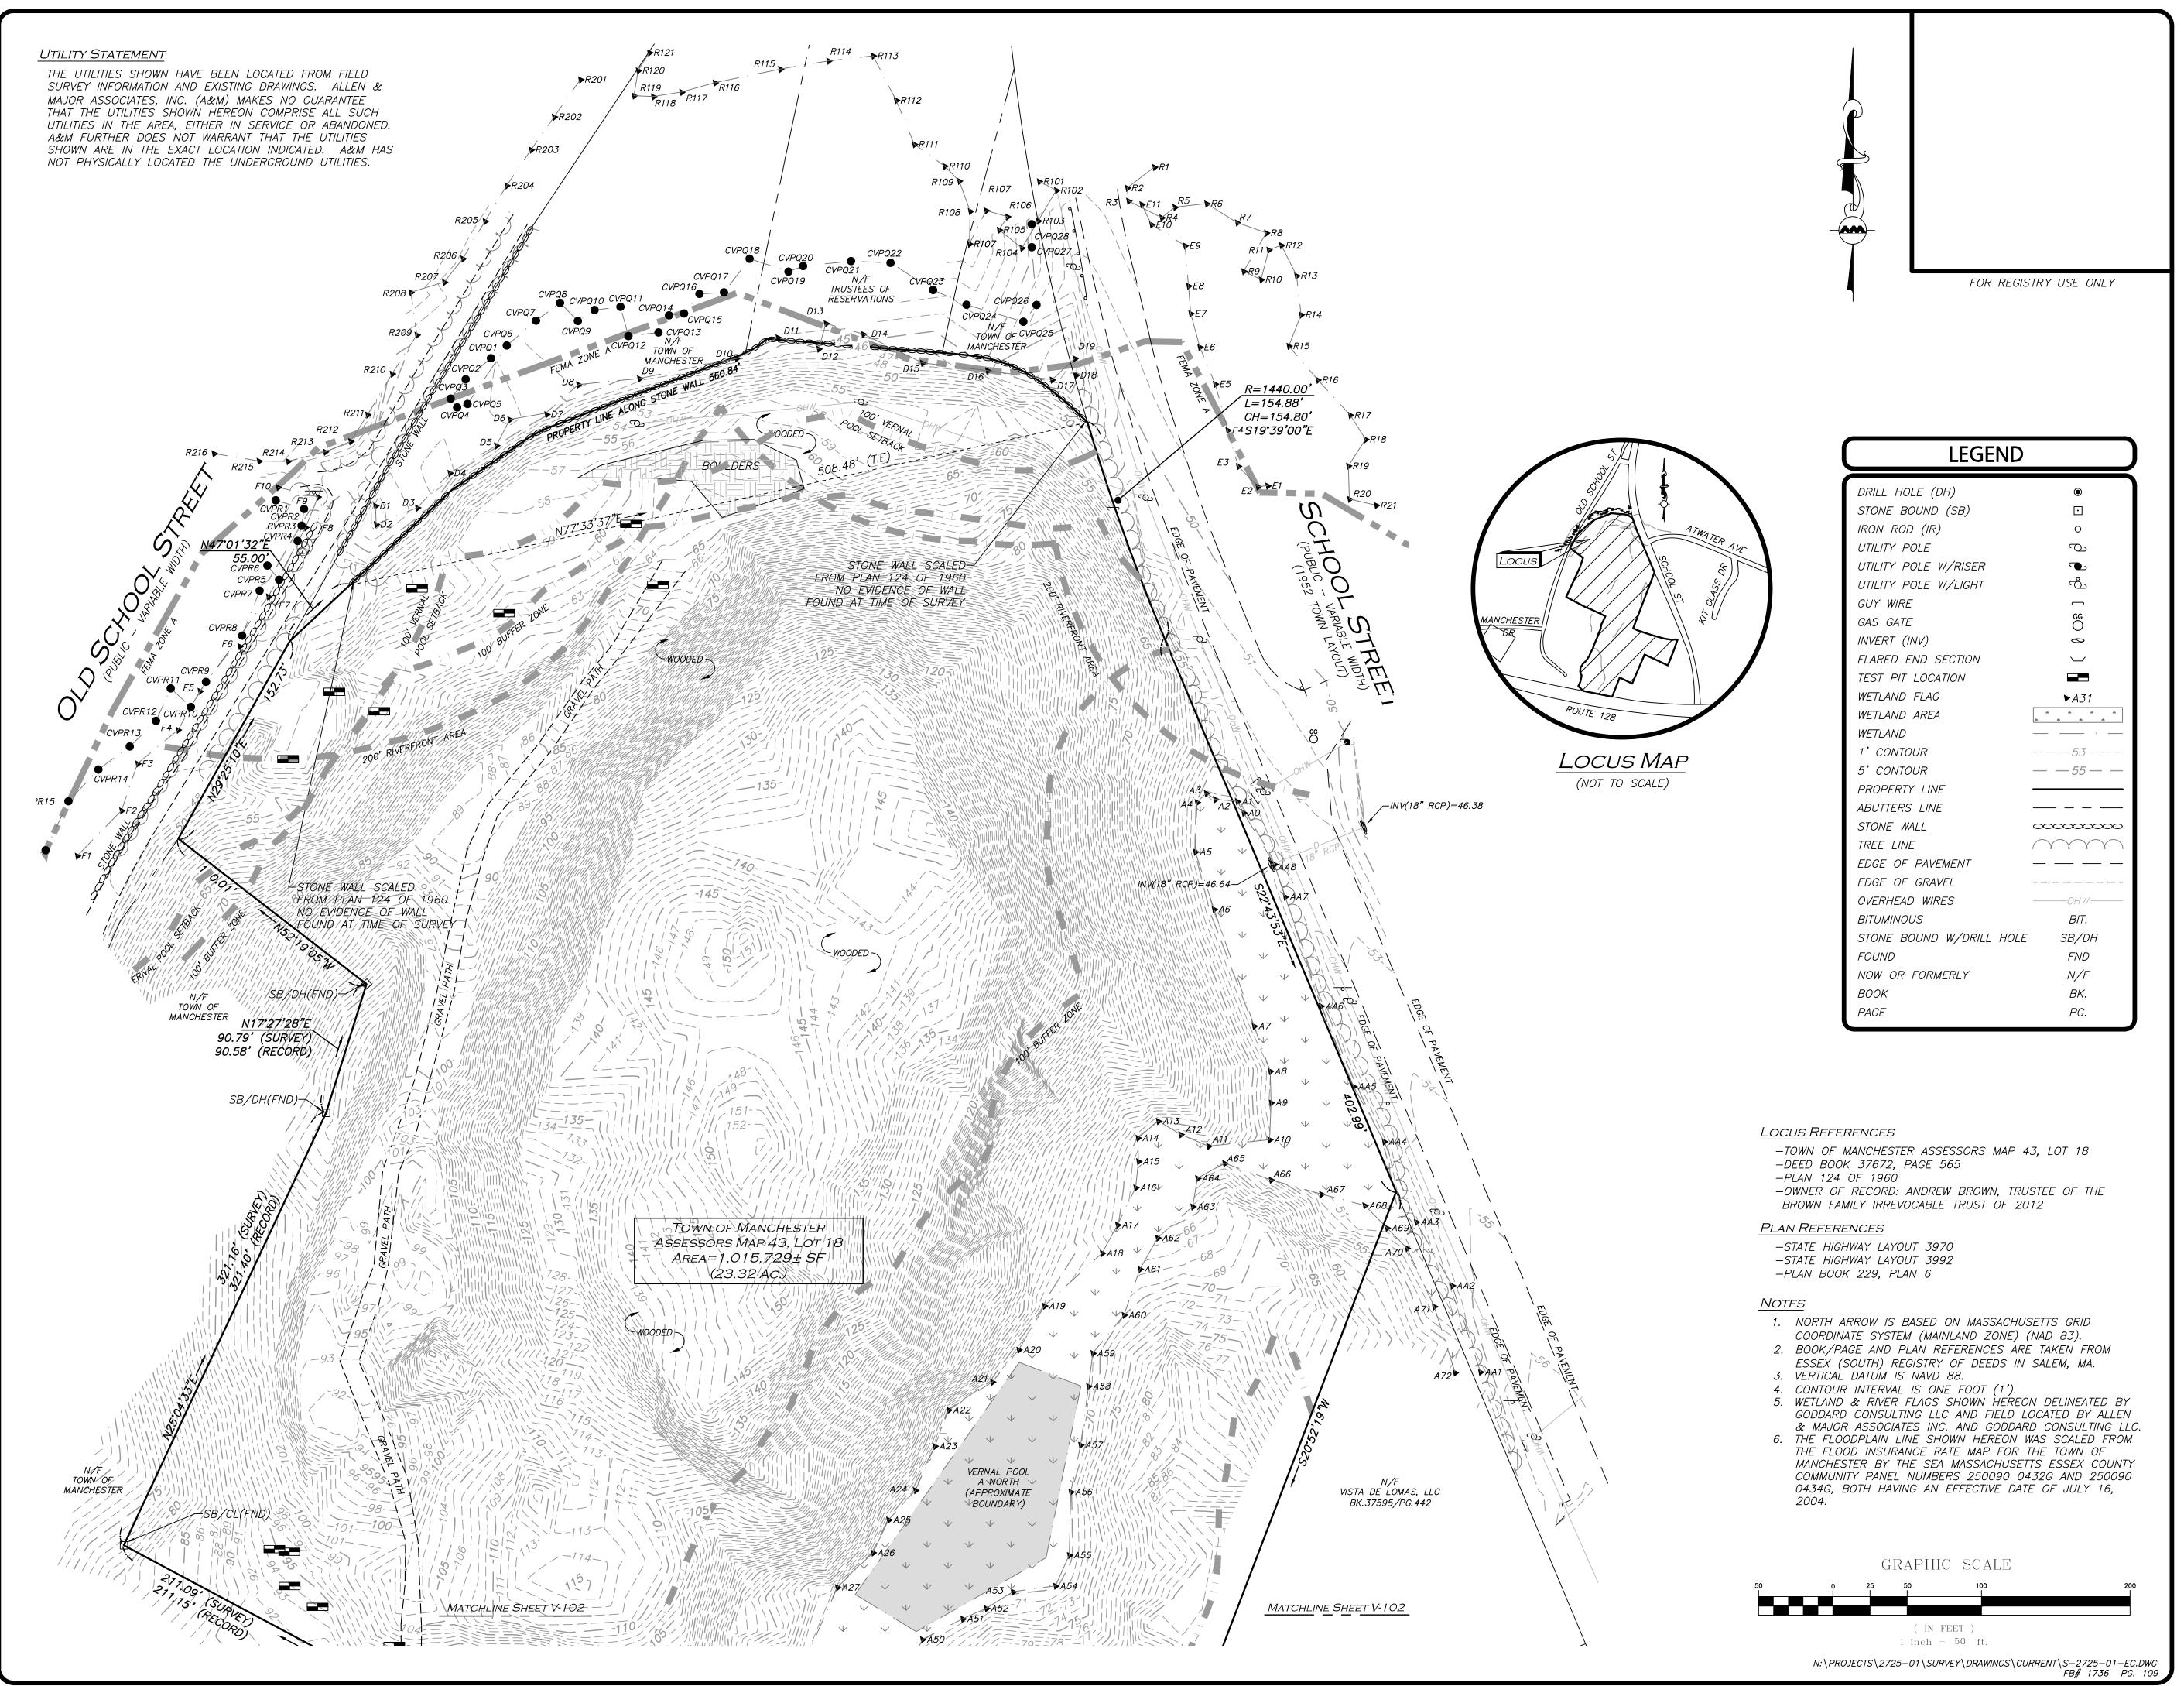
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ABBREVIATIONS & NOTES C-002

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WE HEREBY CERTIFY THAT:

THIS PLAN IS THE RESULT OF AN ACTUAL ON THE GROUND SURVEY PERFORMED ON OR BETWEEN NOVEMBER 21, 2019 AND APRIL 22,

THIS PLAN WAS PREPARED IN ACCORDANCE

WITH THE RULES AND REGULATIONS OF THE REGISTERS OF DEEDS DATED JANUARY 1, 1976 AND REVISED JANUARY 12, 1988. ACCORDING TO DEEDS AND PLANS OF RECORD, THE PROPERTY LINES SHOWN ON THIS PLAN ARE THE LINES DIVIDING EXISTING OWNERSHIP, AND THE LINES OF THE STREETS OR WAYS SHOWN ARE THOSE OF PUBLIC OR PRIVATE STREETS AND WAYS ALREADY ESTABLISHED, AND THAT NO NEW LINES FOR THE DIVISION OF EXISTING OWNERSHIP OR FOR NEW WAYS ARE SHOWN.

THE ABOVE CERTIFICATION IS INTENDED TO MEET REGISTRY OF DEEDS REQUIREMENTS FOR THE RECORDING OF PLANS AND IS NOT A CERTIFICATION TO THE TITLE OR OWNERSHIP OF THE PROPERTY SHOWN. OWNERS OF ADJOINING PROPERTIES ARE SHOWN ACCORDING TO CURRENT TOWN OF MANCHESTER ASSESSOR'S INFORMATION. THE ABOVE IS CERTIFIED TO THE BEST OF MY PROFESSIONAL KNOWLEDGE, INFORMATION AND BELIEF.

ALLEN & MAJOR ASSOCIATES, INC.

PROFESSIONAL LAND SURVEYOR FOR ALLEN & MAJOR ASSOCIATES, INC.



7.	03/07/22	VARIOUS REVISIONS
6.	05/27/21	100' BUFFER ZONE ADDED
5.	04/27/21	WETLAND LOCATION REVISION
4.	12/22/20	WETLAND LOCATION REVISION
3.	12/11/20	TEST PIT LOCATIONS ADDED
2.	11/19/20	RIVERFRONT BUFFERS ADDED
1.	11/18/20	WETLAND/RIVER FLAGS ADDED
REV	DATE	DESCRIPTION

APPLICANT\OWNER:

SLV SCHOOL STREET, LLC **257 HILLSIDE AVENUE** NEEDHAM, MA 02494

PROJECT:

ASSESSORS MAP 43, LOT 18 SCHOOL STREET MANCHESTER BY THE SEA, MA

2725-01 DATE: PROJECT NO. 09/21/2020 SCALE: 1" = 50' DWG. NAME: S-2725-01-EC DRAFTED BY: KAC | CHECKED BY:



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SHEET No.

V-101


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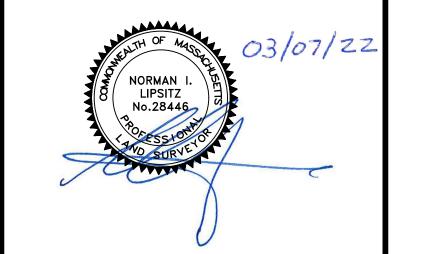
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ALLEN & MAJOR ASSOCIATES, INC.

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PROJECT:

ASSESSORS MAP 43, LOT 18
SCHOOL STREET
MANCHESTER BY THE SEA, MA

 PROJECT NO.
 2725-01
 DATE:
 09/21/2020

 SCALE:
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 DWG. NAME:
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 DRAFTED BY:
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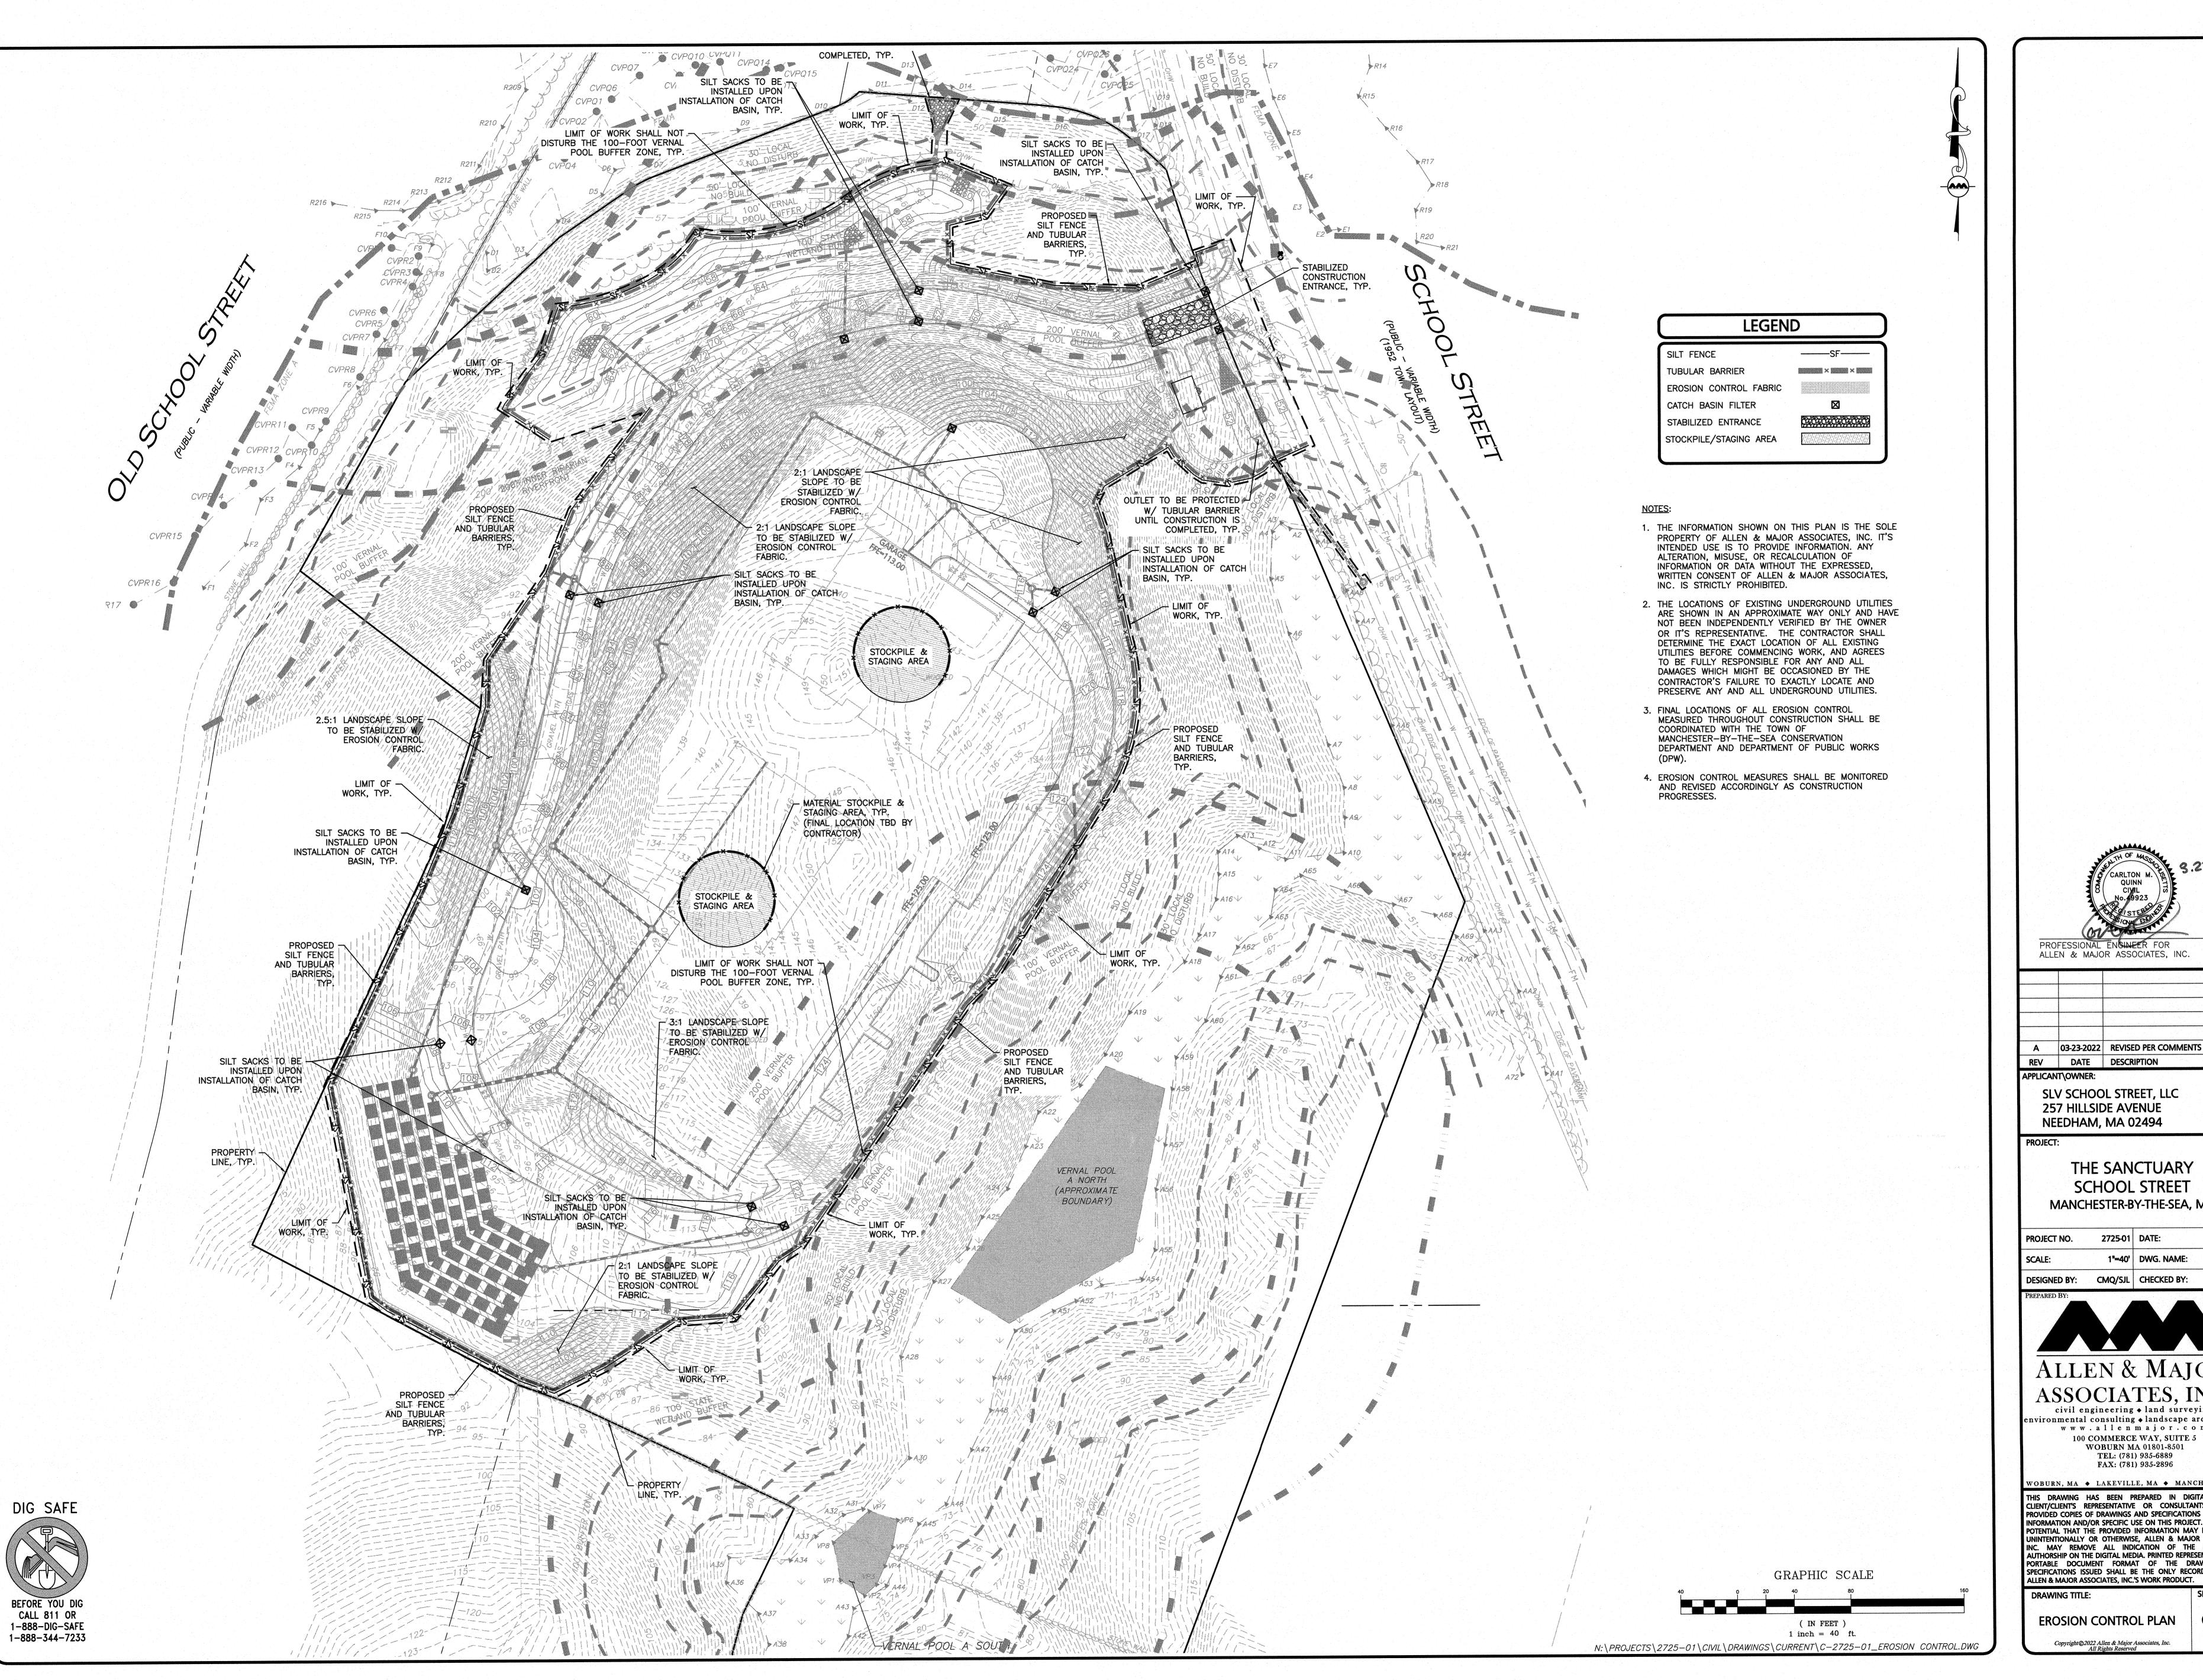
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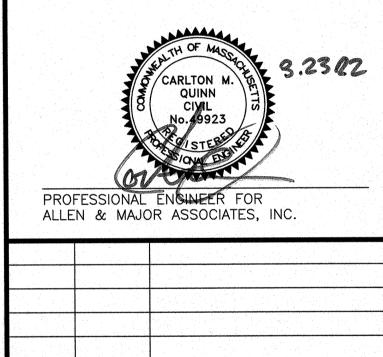
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DITIONS V-102

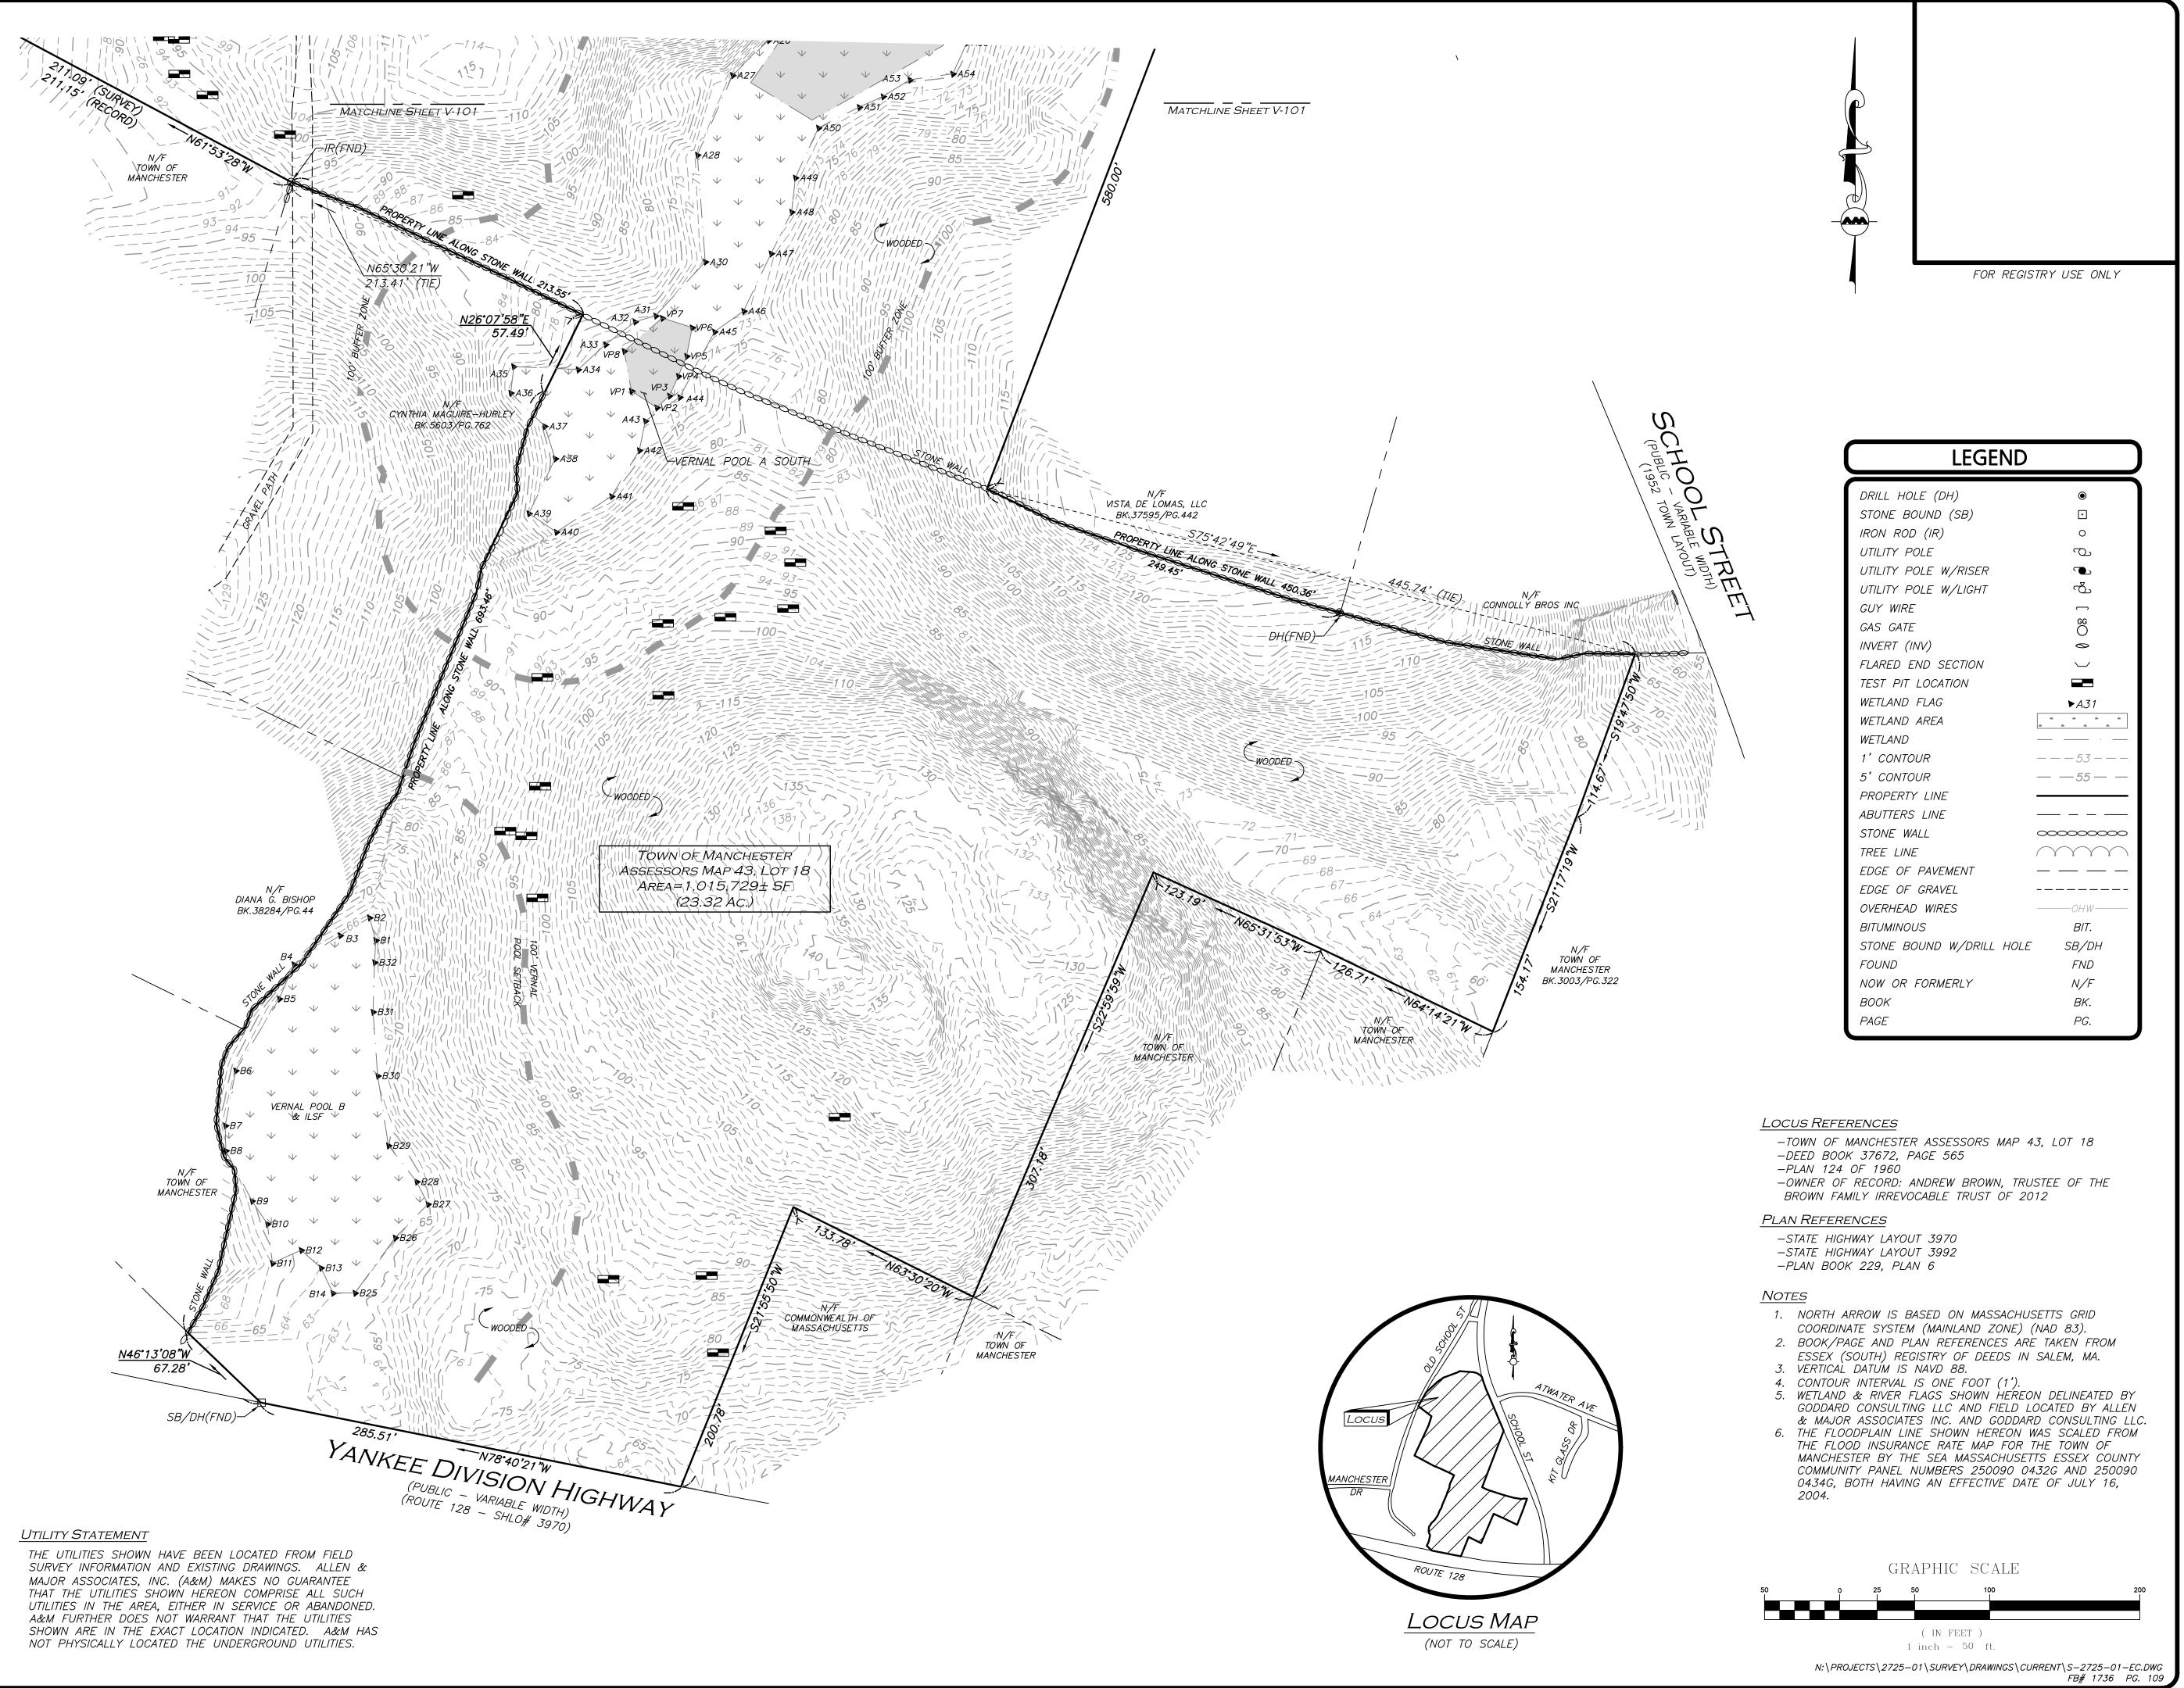SHEET No.





APPLICANT\OWNER: SLV SCHOOL STREET, LLC **257 HILLSIDE AVENUE**

PROJECT:

THE SANCTUARY SCHOOL STREET MANCHESTER-BY-THE-SEA, MA

07-16-2021 PROJECT NO. DESIGNED BY: CMQ/SJL CHECKED BY:





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257 HILLSIDE AVENUE NEEDHAM, MA 02494 PROJECT:

SLV SCHOOL STREET, LLC

THE SANCTUARY SCHOOL STREET MANCHESTER-BY-THE-SEA, MA

PROJECT NO.	2725-01	DATE:	07-16-202
SCALE:	1"=40'	DWG. NAME:	C-2725-0
DESIGNED BY:	CMQ/SJL	CHECKED BY:	СМ
DDEDARED DV.			

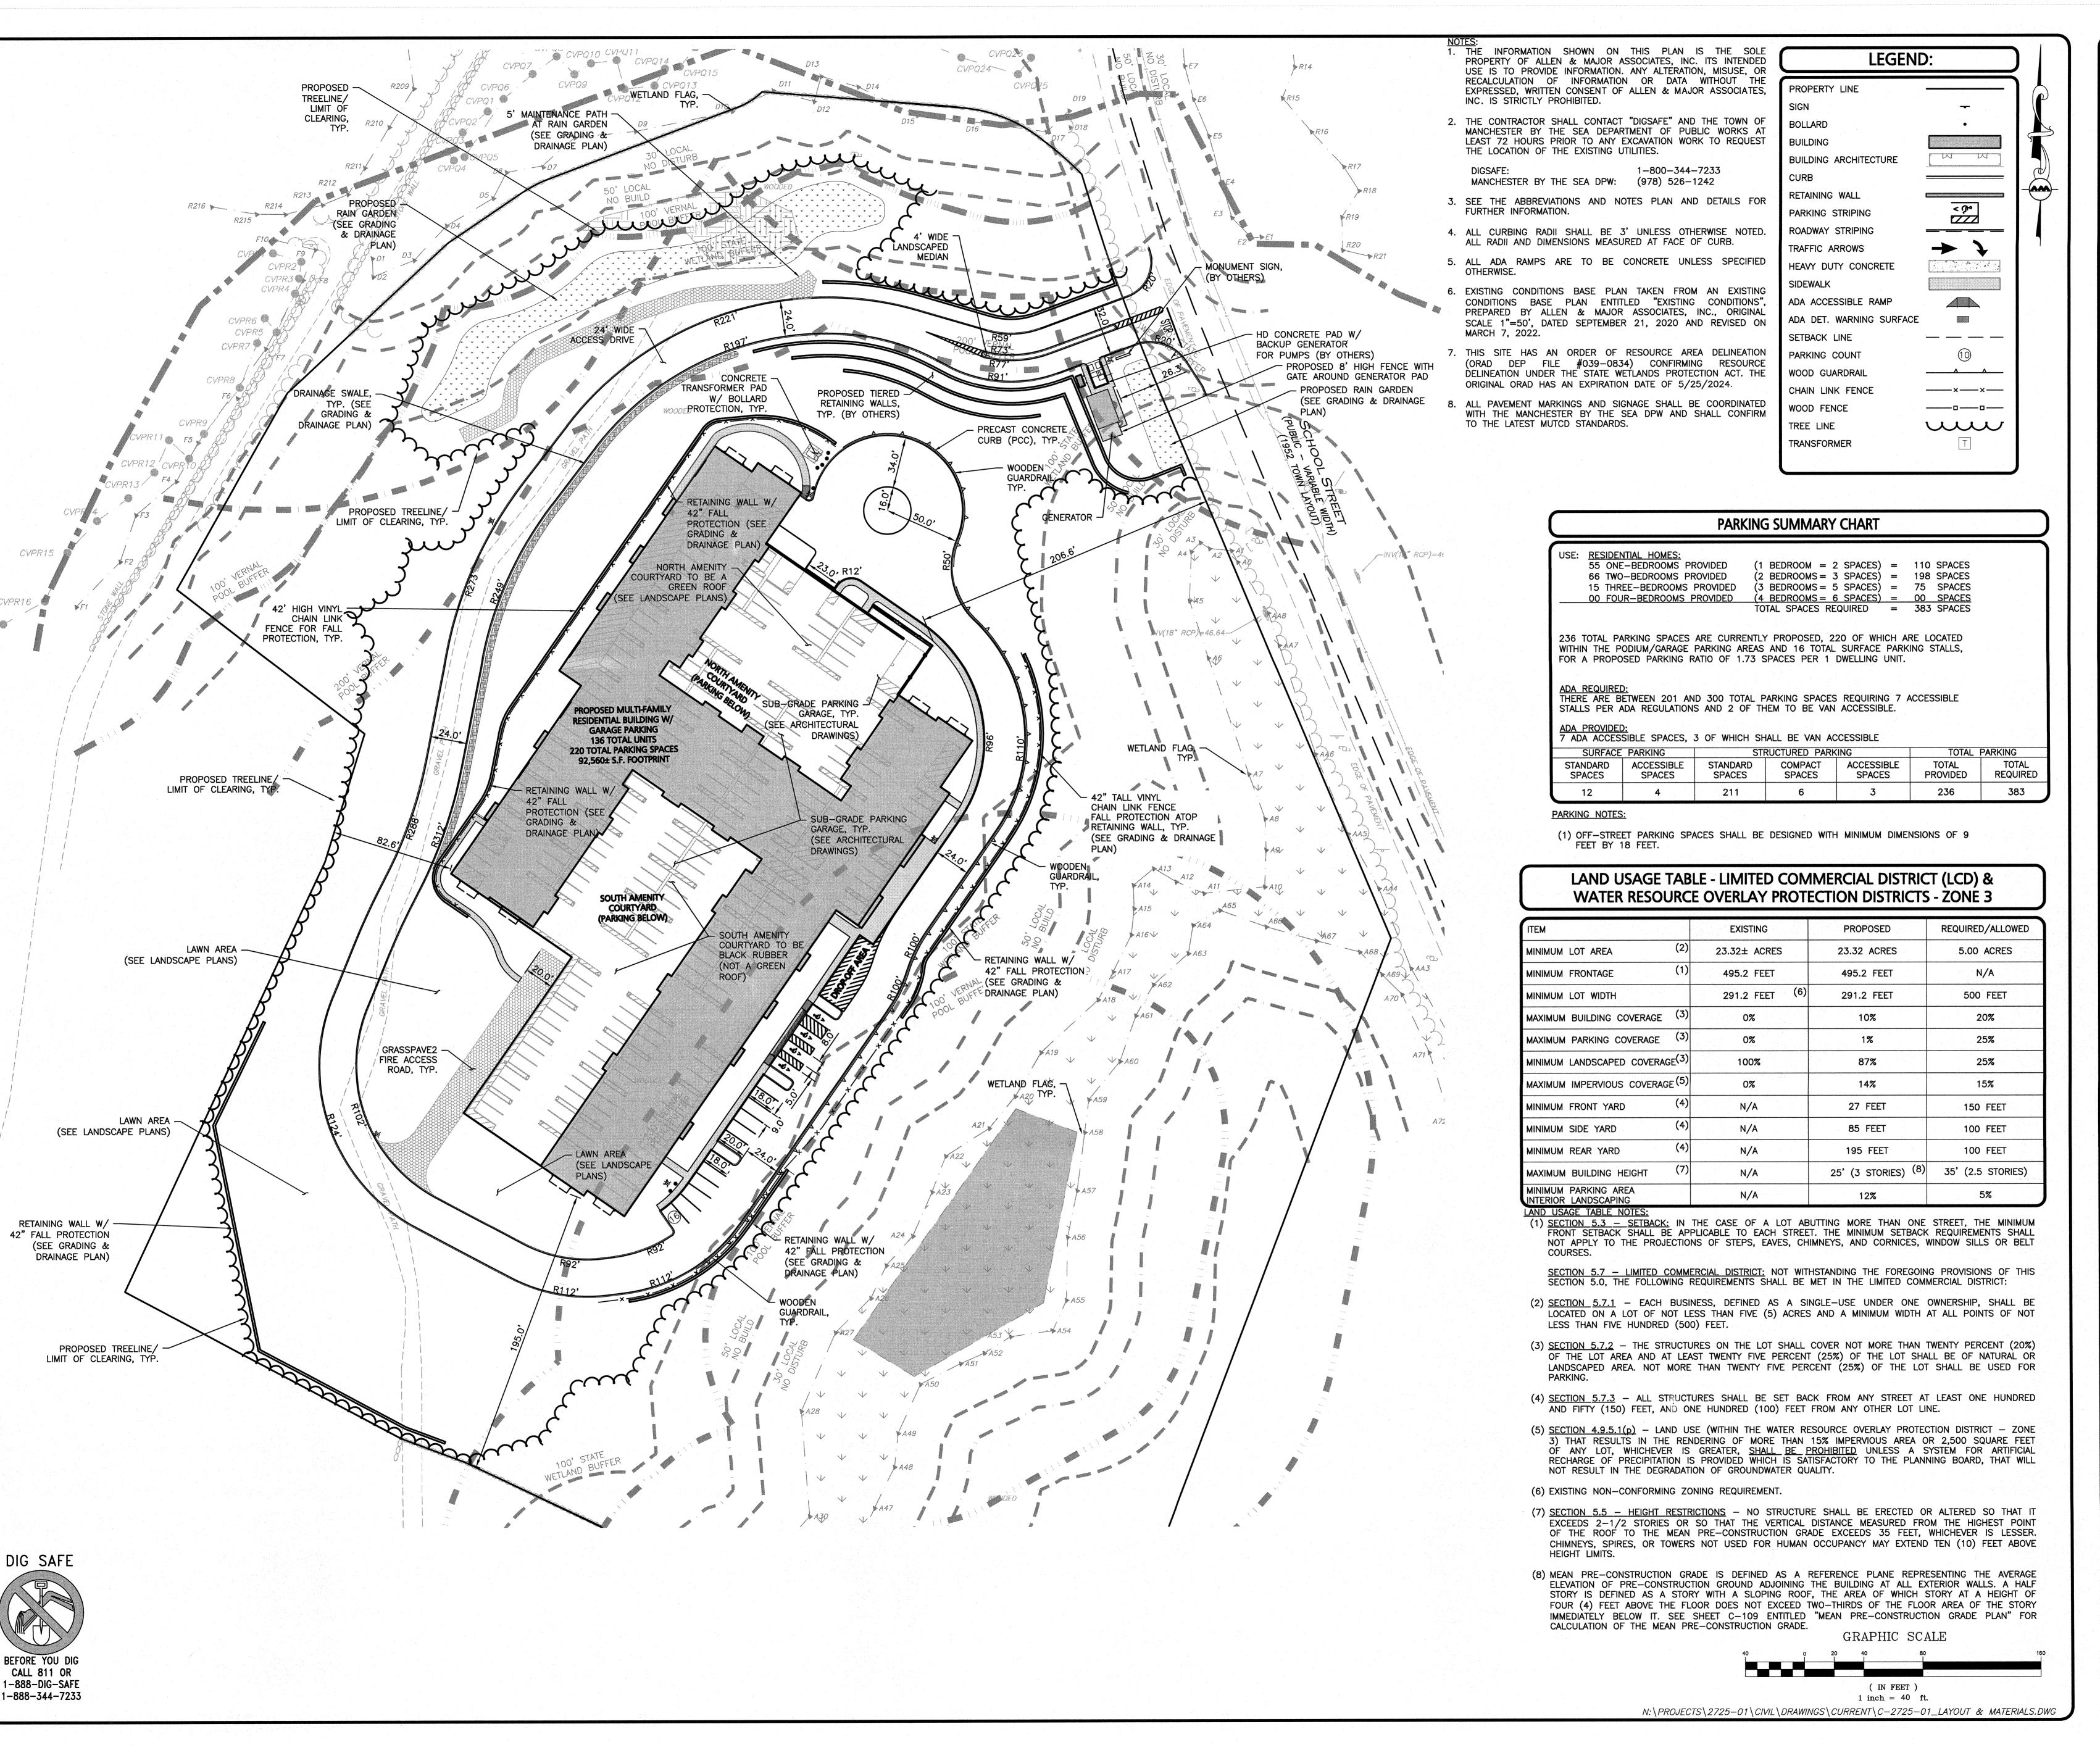
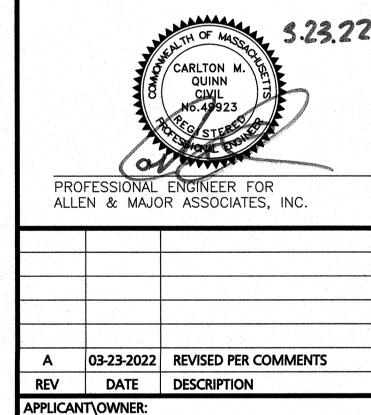
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FAX: (781) 935-2896


www.allenmajor.com 100 COMMERCE WAY, SUITE 5 WOBURN MA 01801-8501 TEL: (781) 935-6889


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SHEET No.

LAYOUT & MATERIALS PLAN C-102.



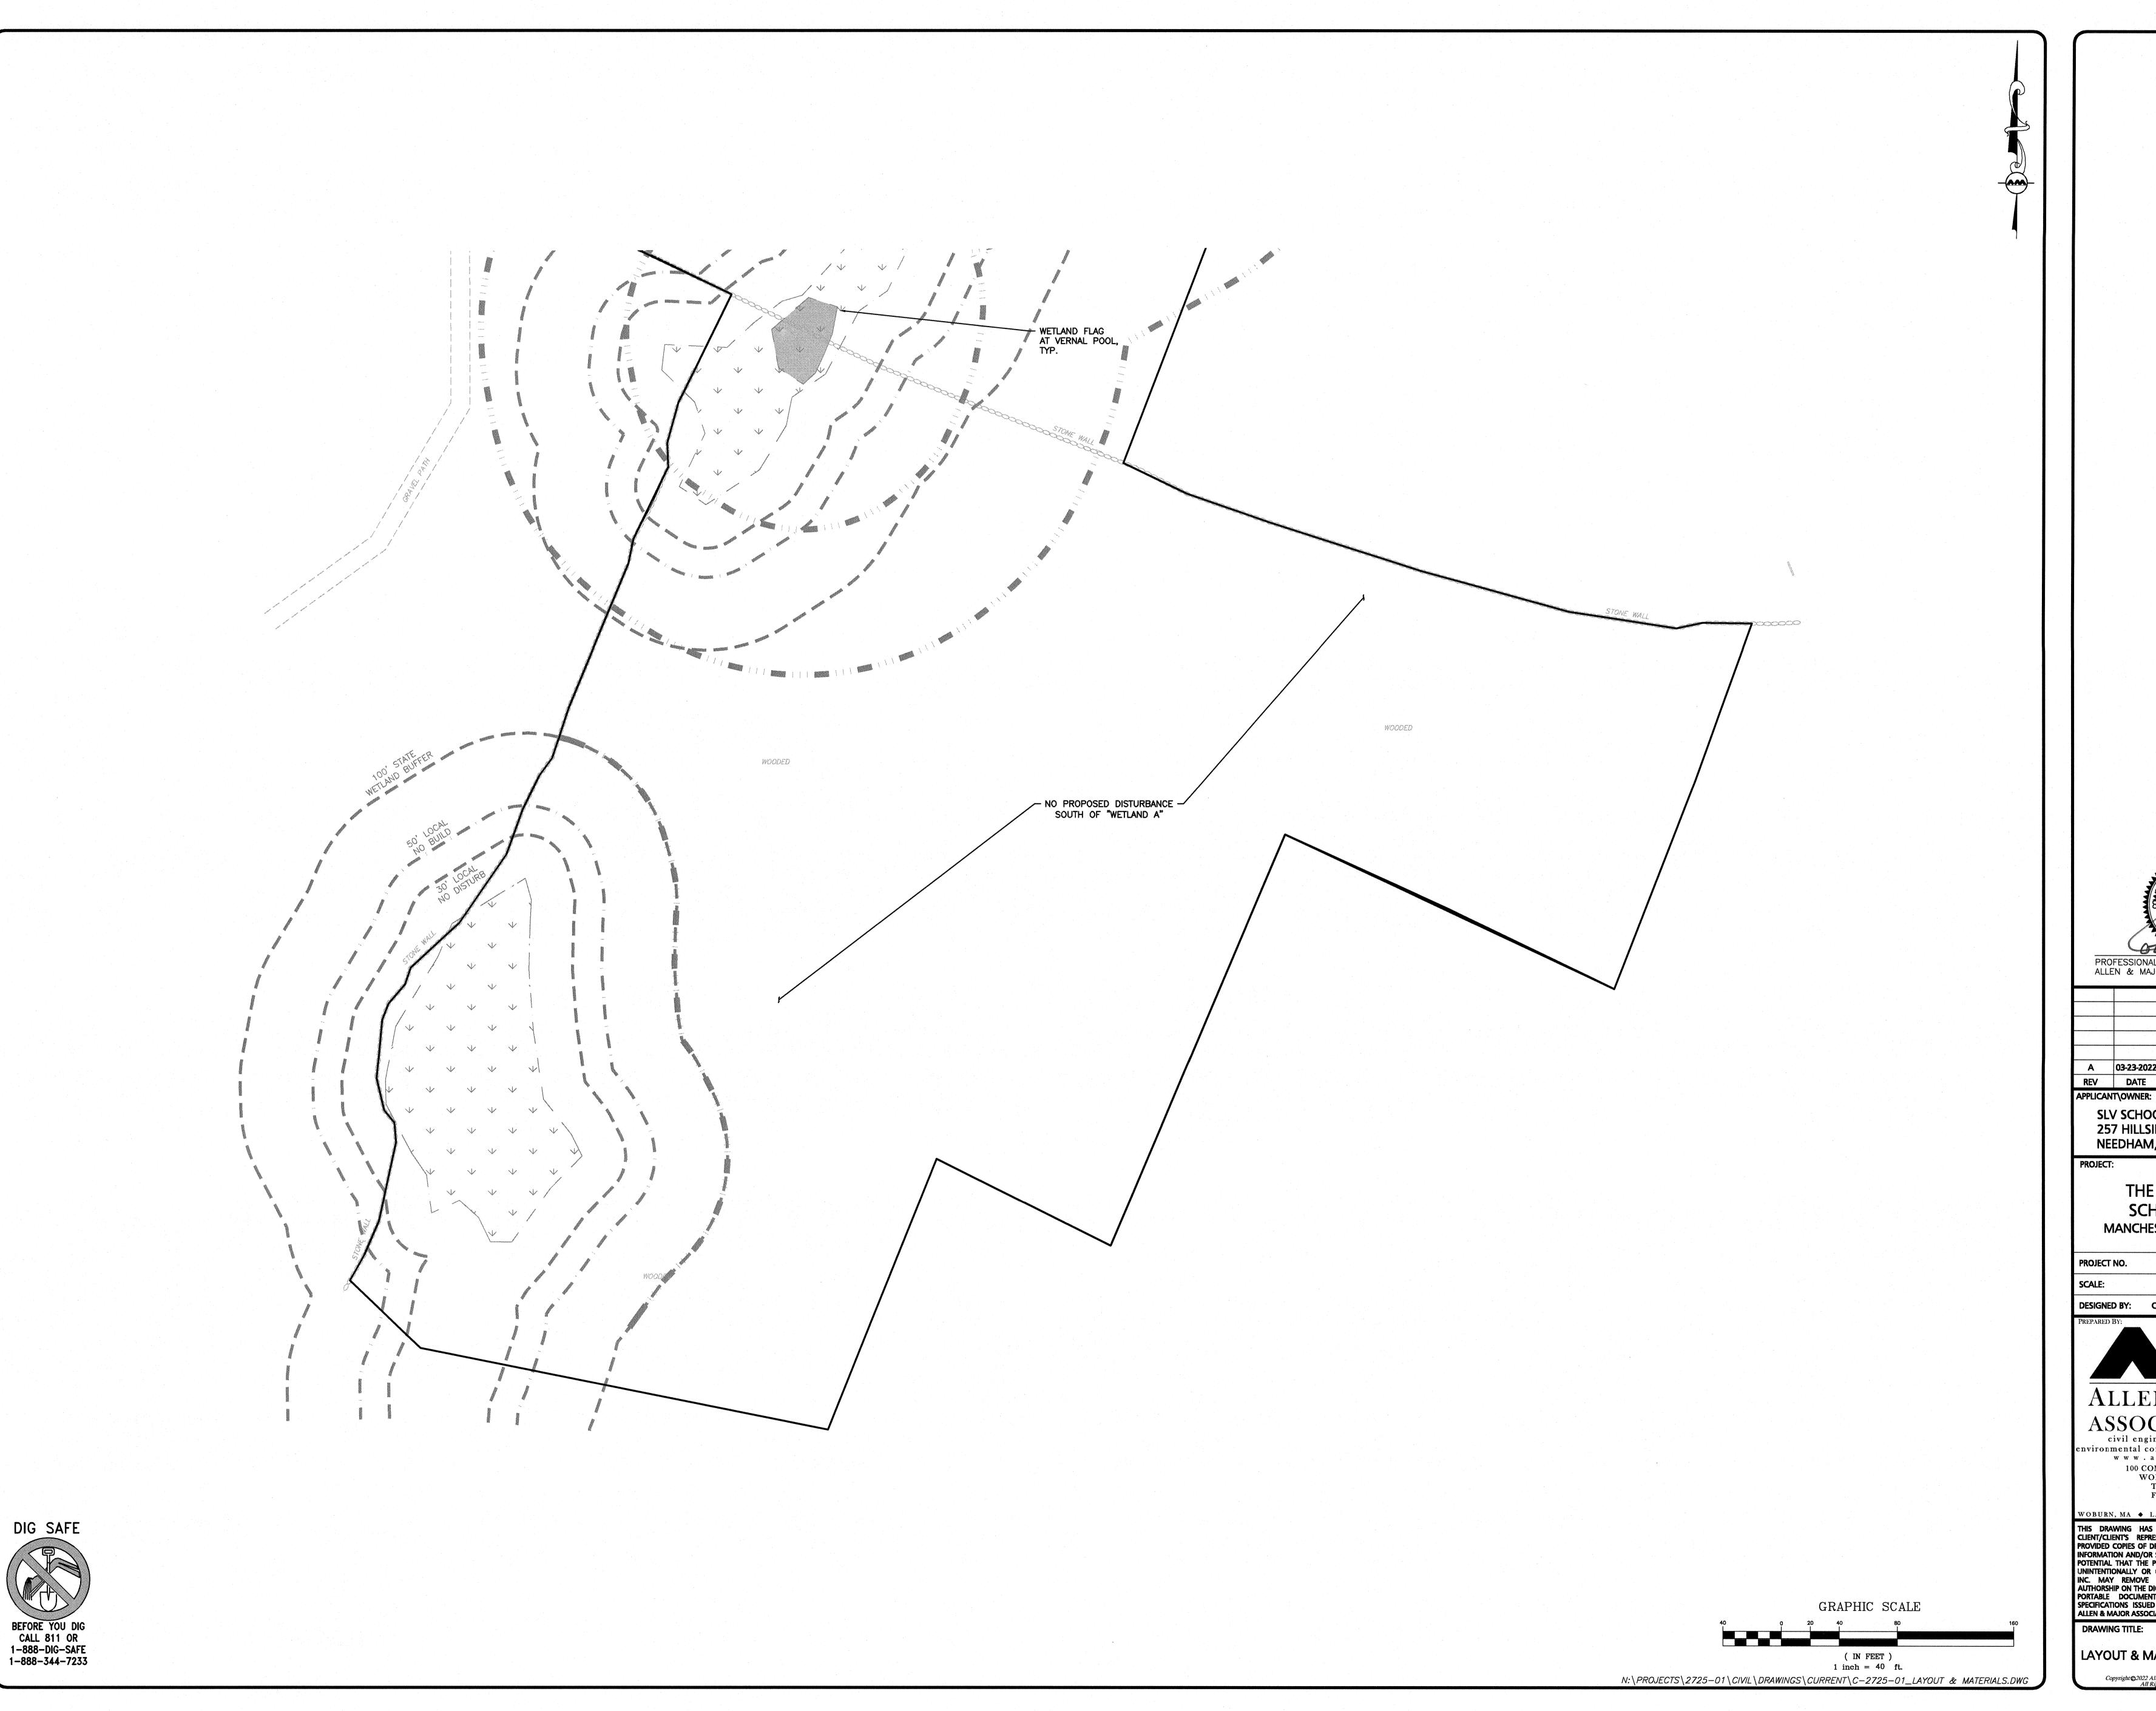

A 03-23-2022 REVISED PER COMMENTS
REV DATE DESCRIPTION

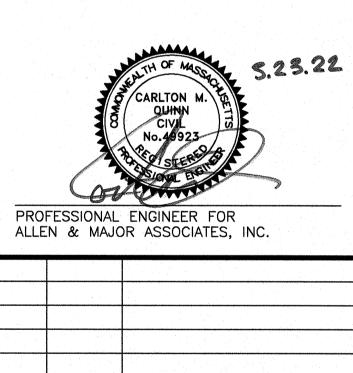SLV SCHOOL STREET, LLC 257 HILLSIDE AVENUE NEEDHAM, MA 02494

THE SANCTUARY SCHOOL STREET MANCHESTER-BY-THE-SEA, MA



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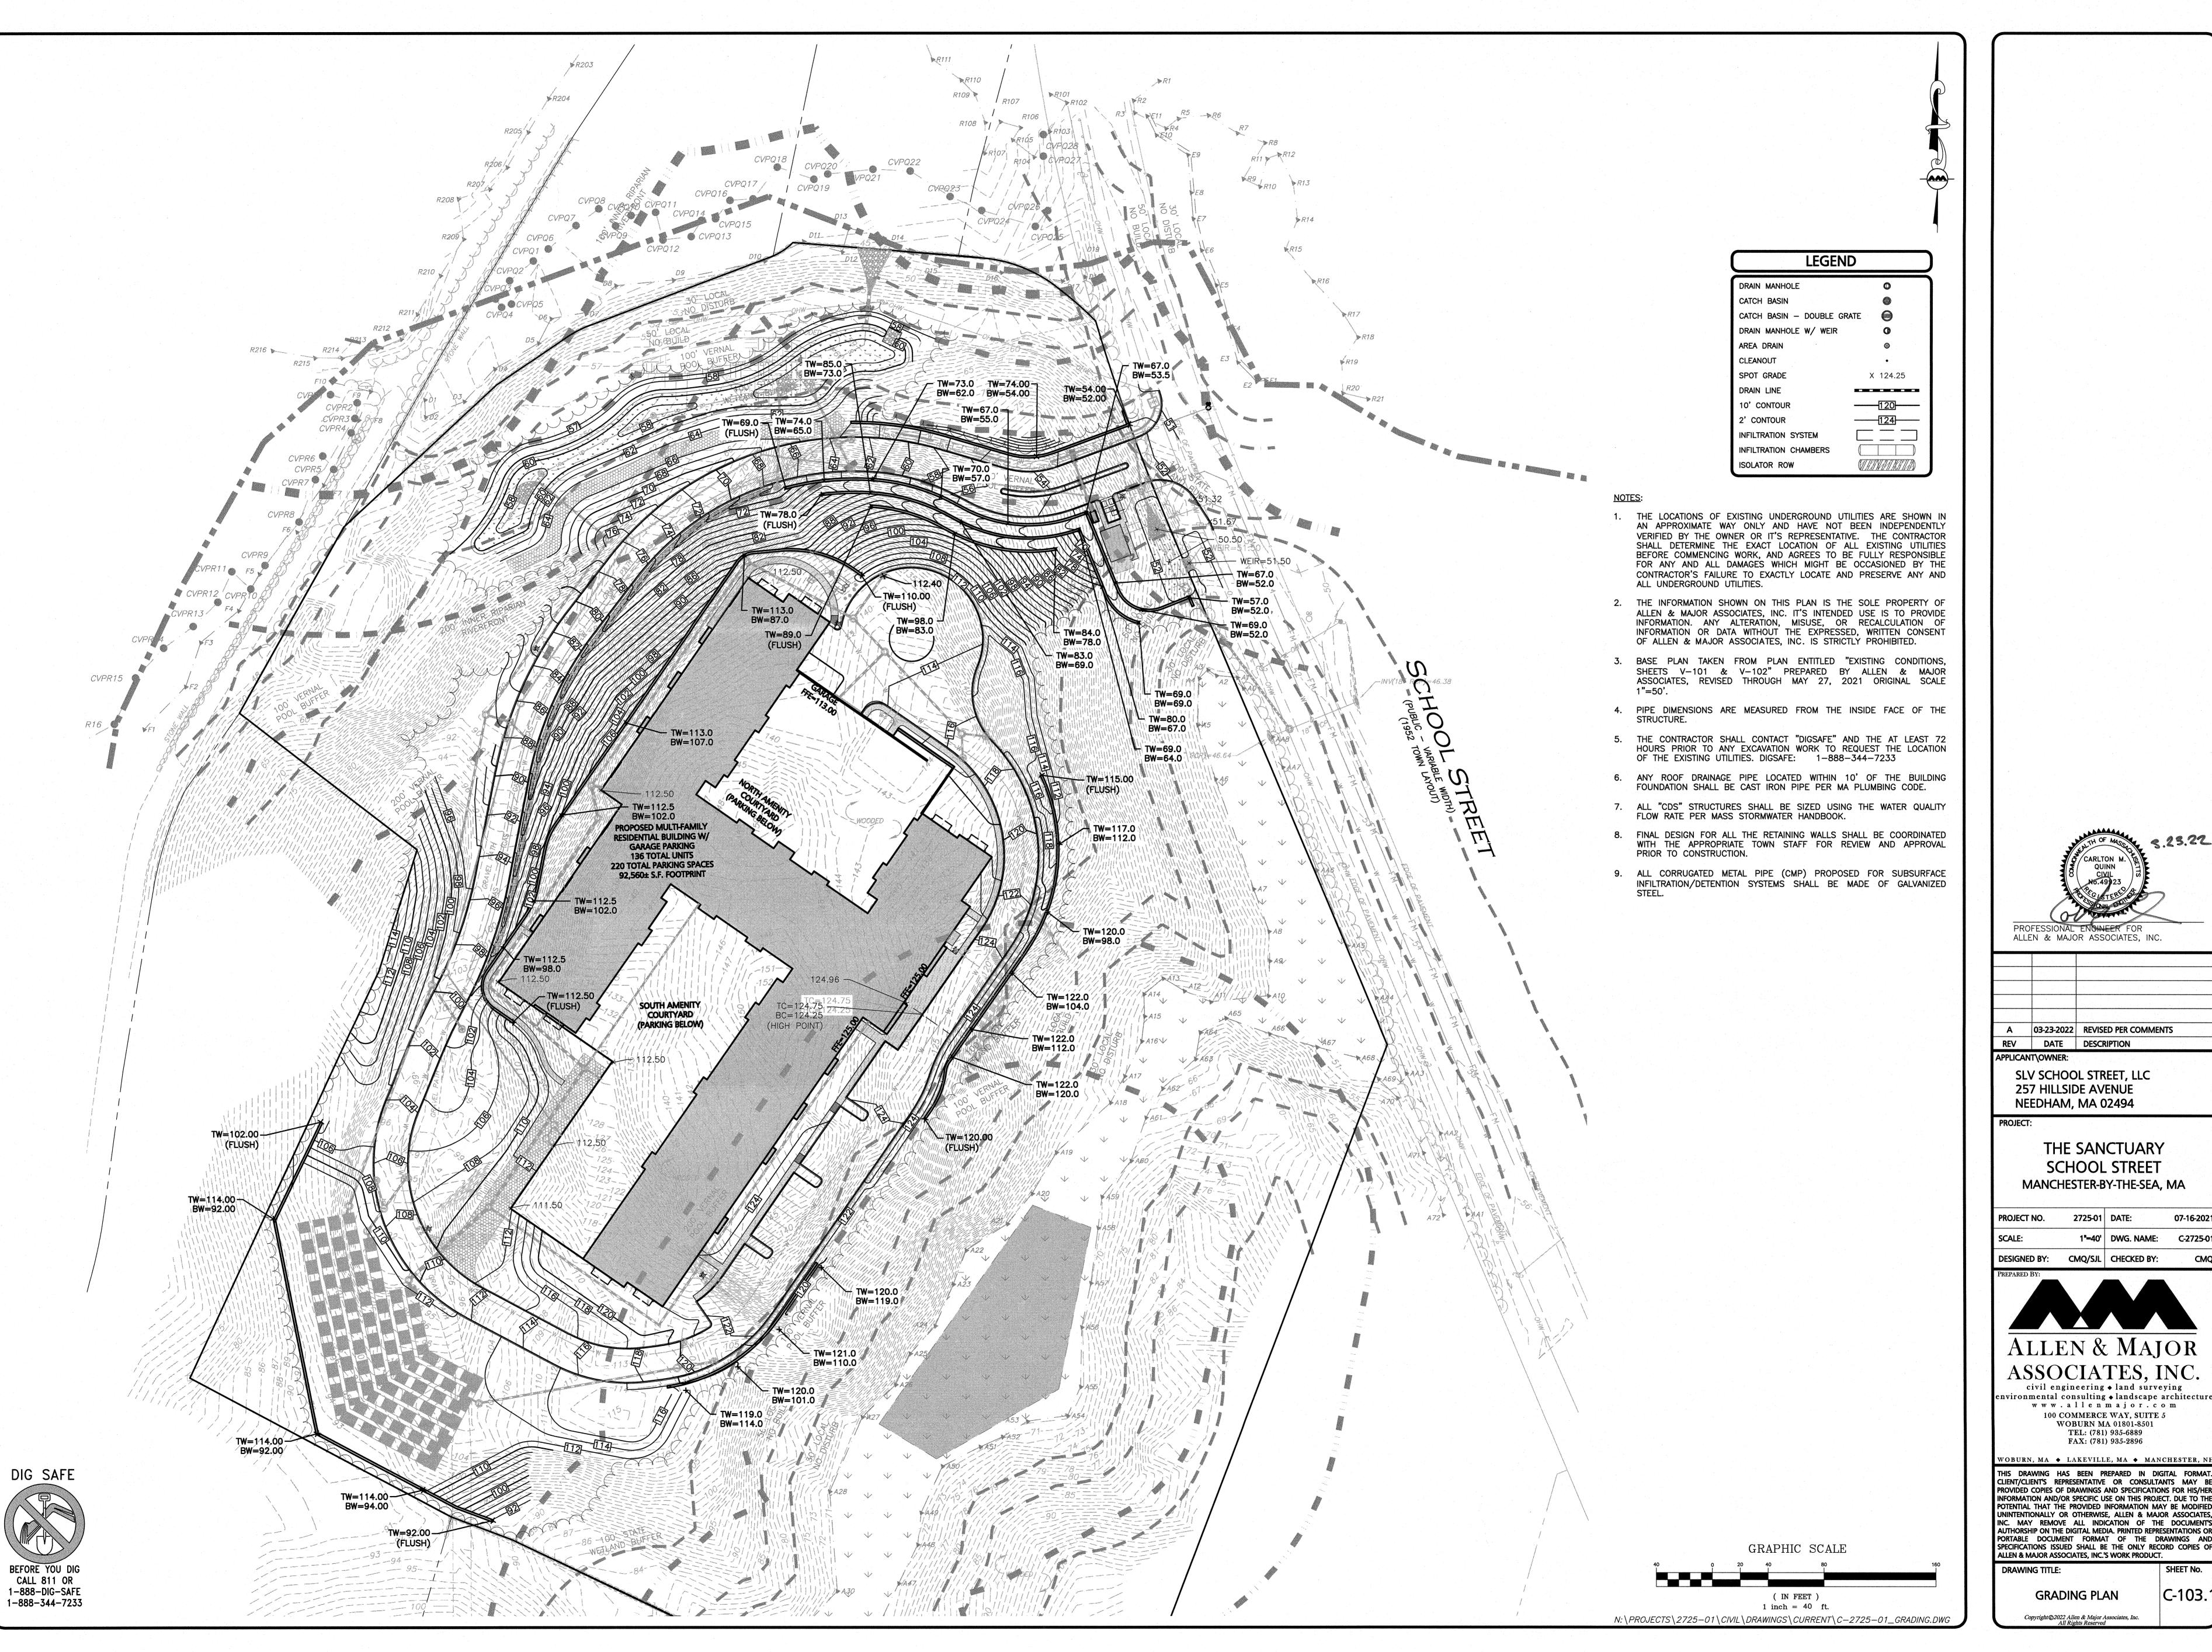
100 COMMERCE WAY, SUITE 5

WOBURN MA 01801-8501

TEL: (781) 935-6889
FAX: (781) 935-2896 WOBURN, MA ♦ LAKEVILLE, MA ♦ MANCHESTER, NH

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DRAWING TITLE: LAYOUT & MATERIALS PLAN C-102.2





A 03-23-2022 REVISED PER COMMENTS

SLV SCHOOL STREET, LLC **257 HILLSIDE AVENUE**

NEEDHAM, MA 02494

THE SANCTUARY SCHOOL STREET MANCHESTER-BY-THE-SEA, MA

PROJECT NO. 2725-01 DATE: 1"=40' DWG. NAME: C-2725-01 DESIGNED BY: CMQ/SJL | CHECKED BY:




ASSOCIATES, INC.


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DRAWING TITLE:





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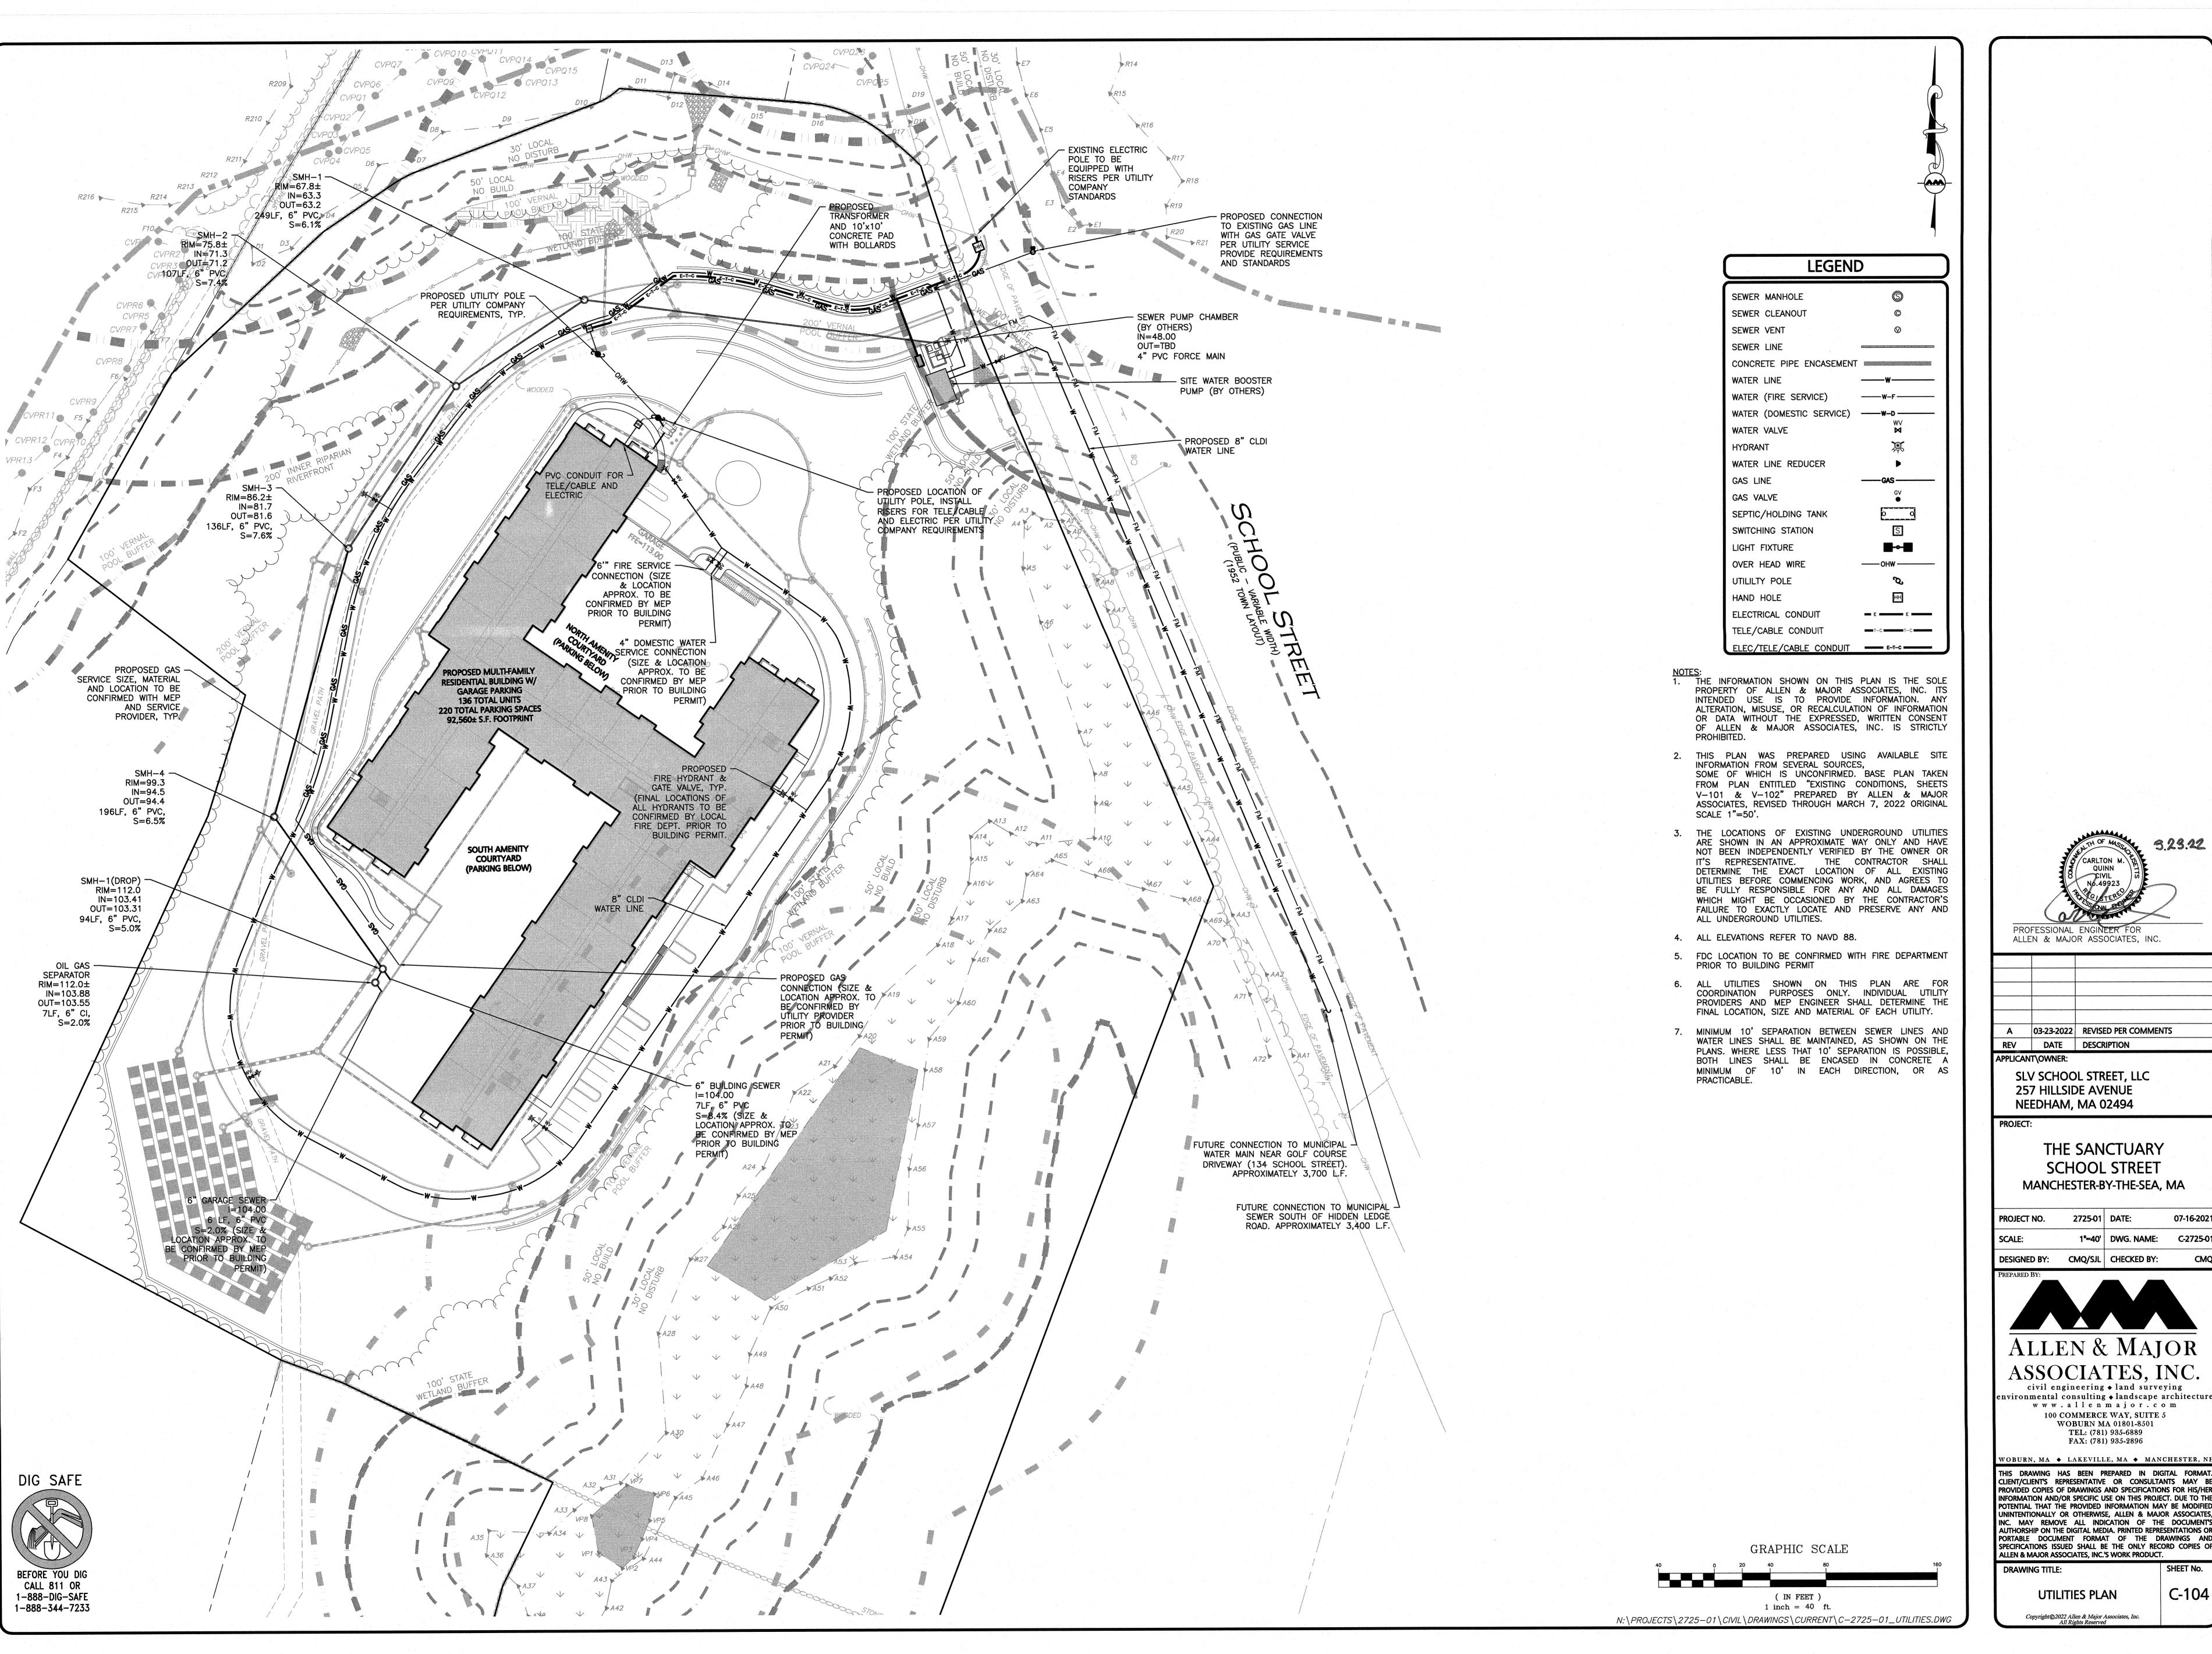
100 COMMERCE WAY, SUITE 5 **WOBURN MA 01801-8501**

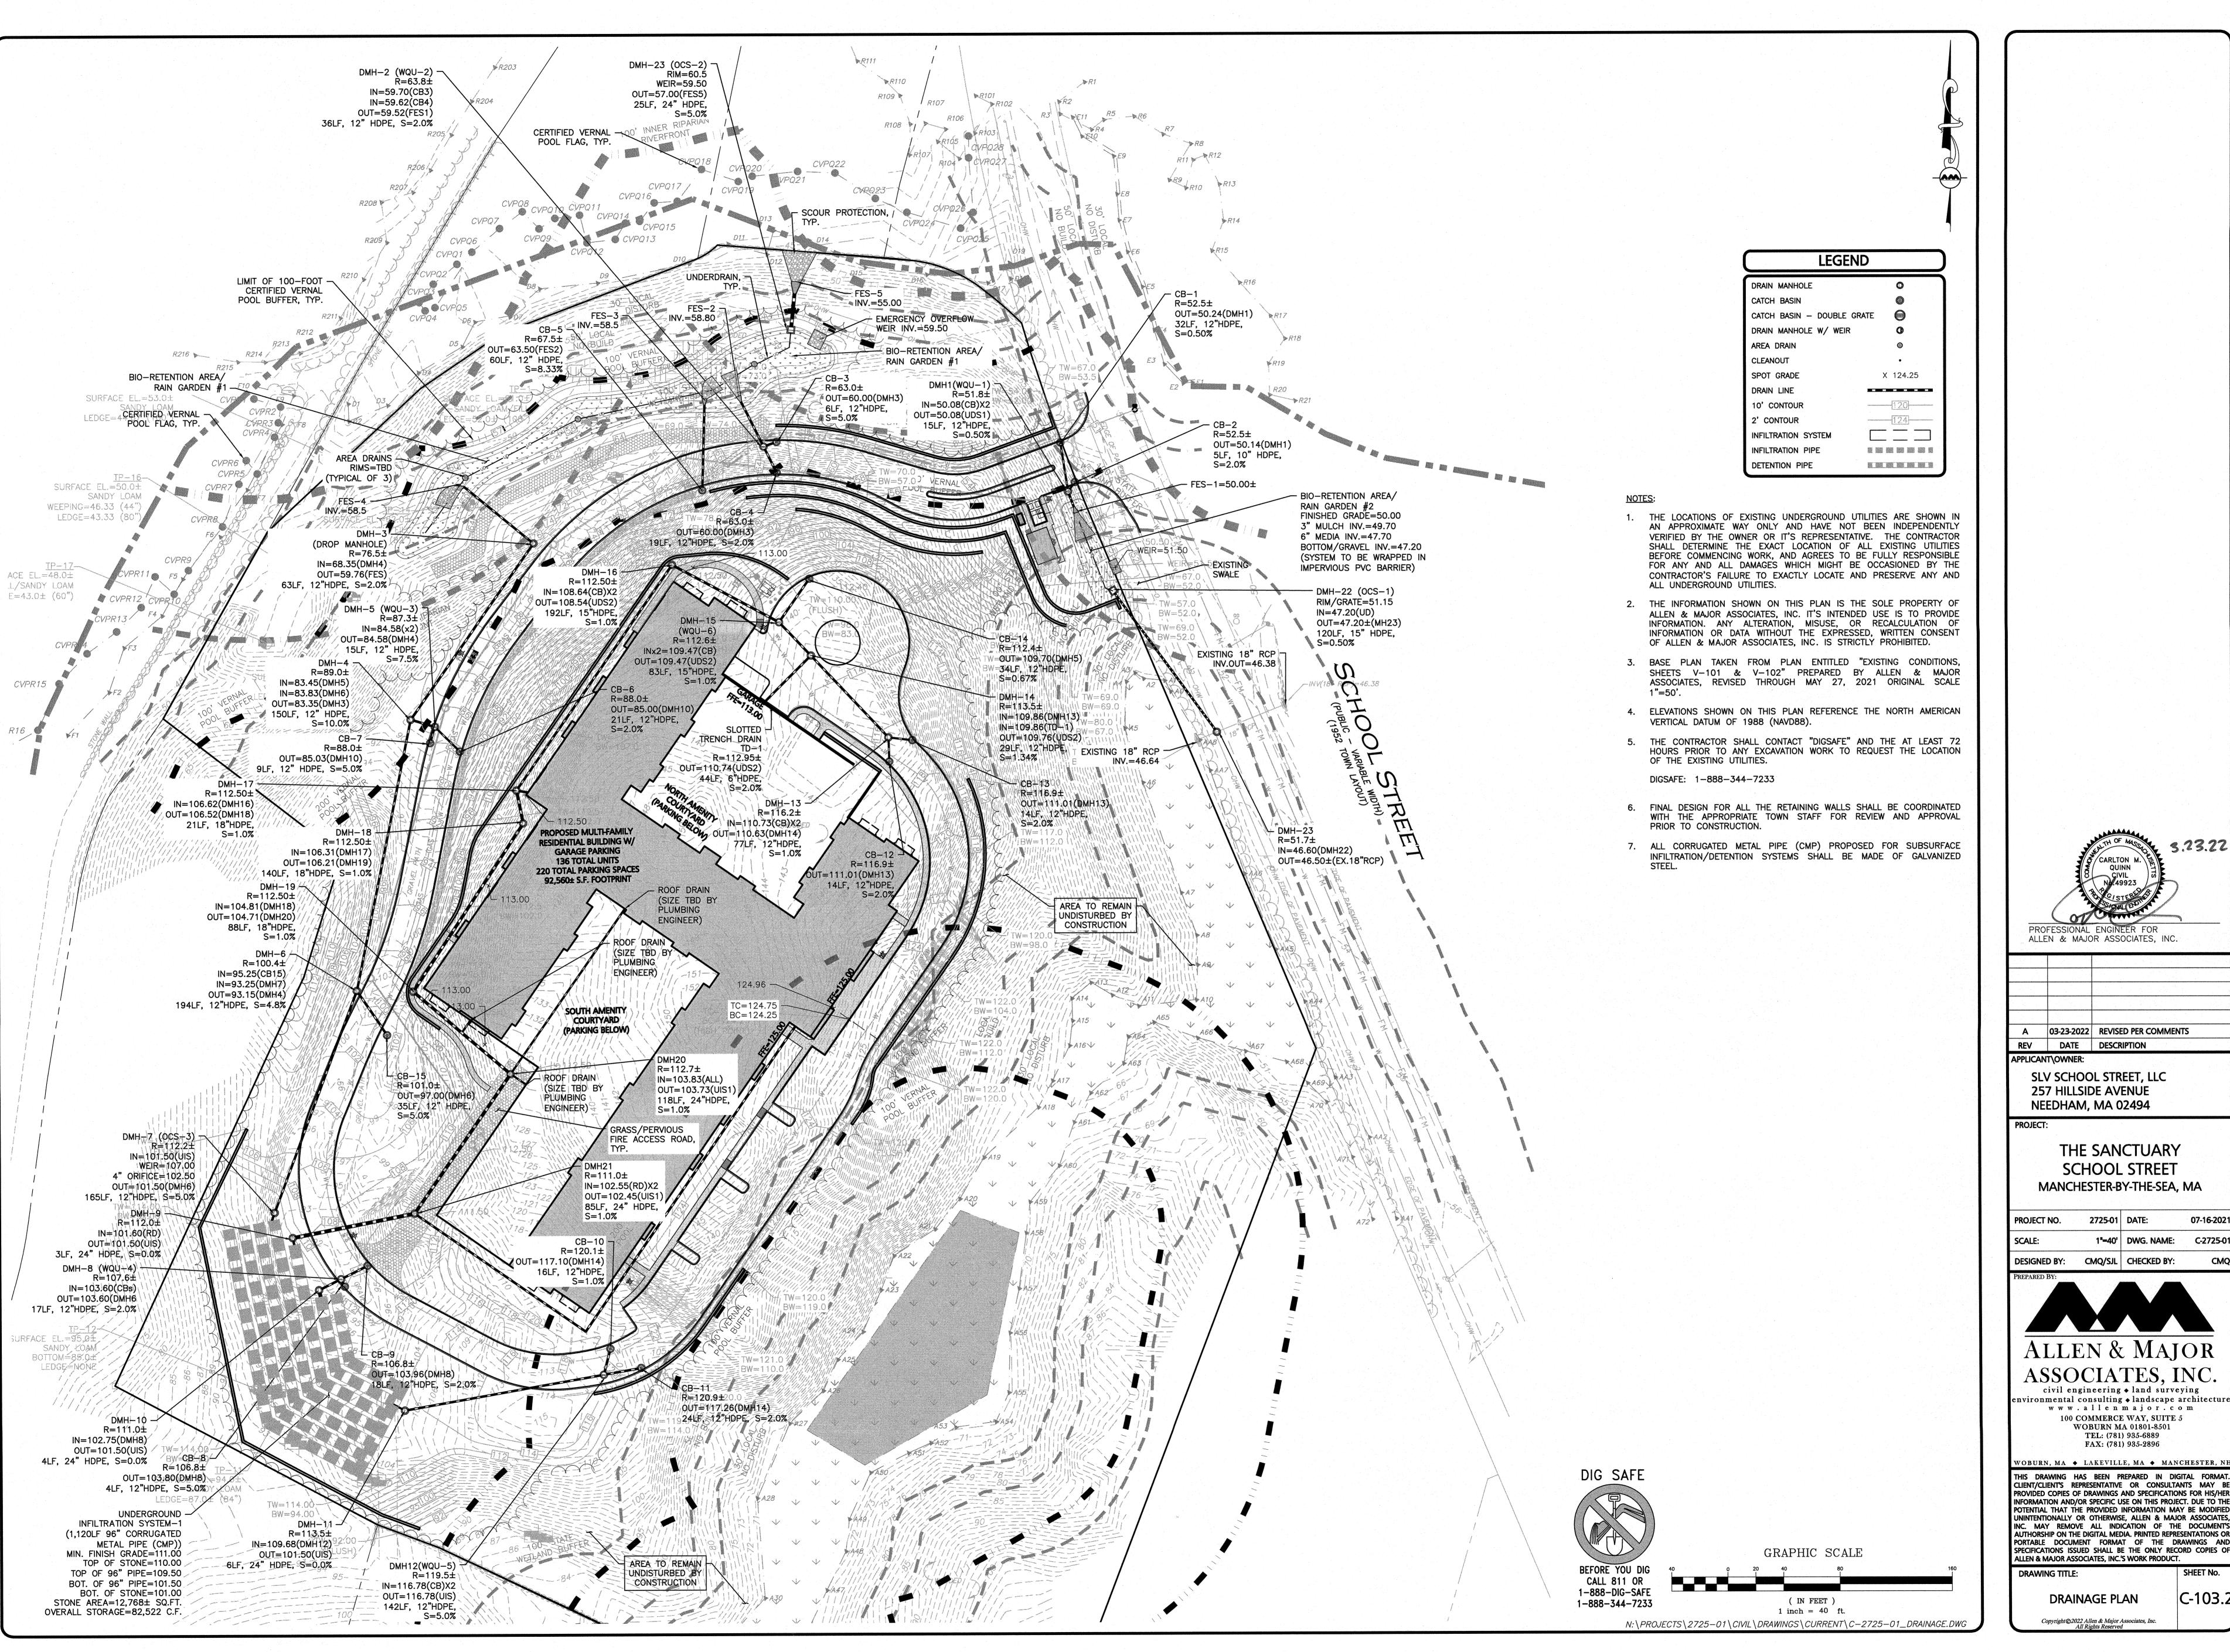
TEL: (781) 935-6889

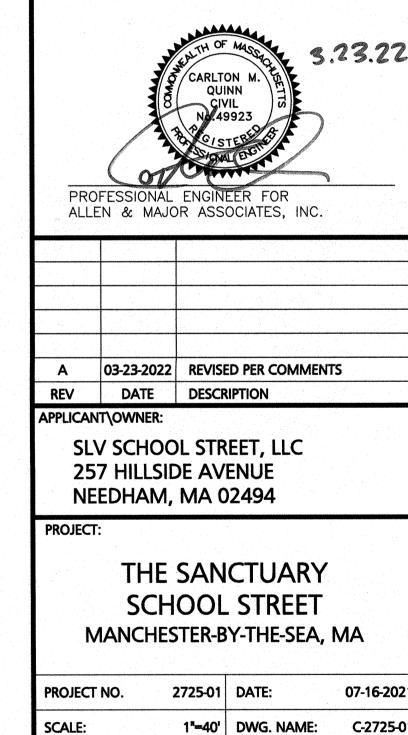FAX: (781) 935-2896

DRAINAGE PLAN

C-103.2



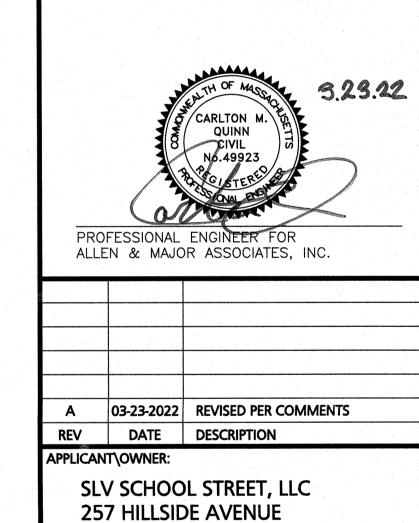

NEEDHAM, MA 02494

THE SANCTUARY

SCHOOL STREET

MANCHESTER-BY-THE-SEA, MA

2725-01 DATE:

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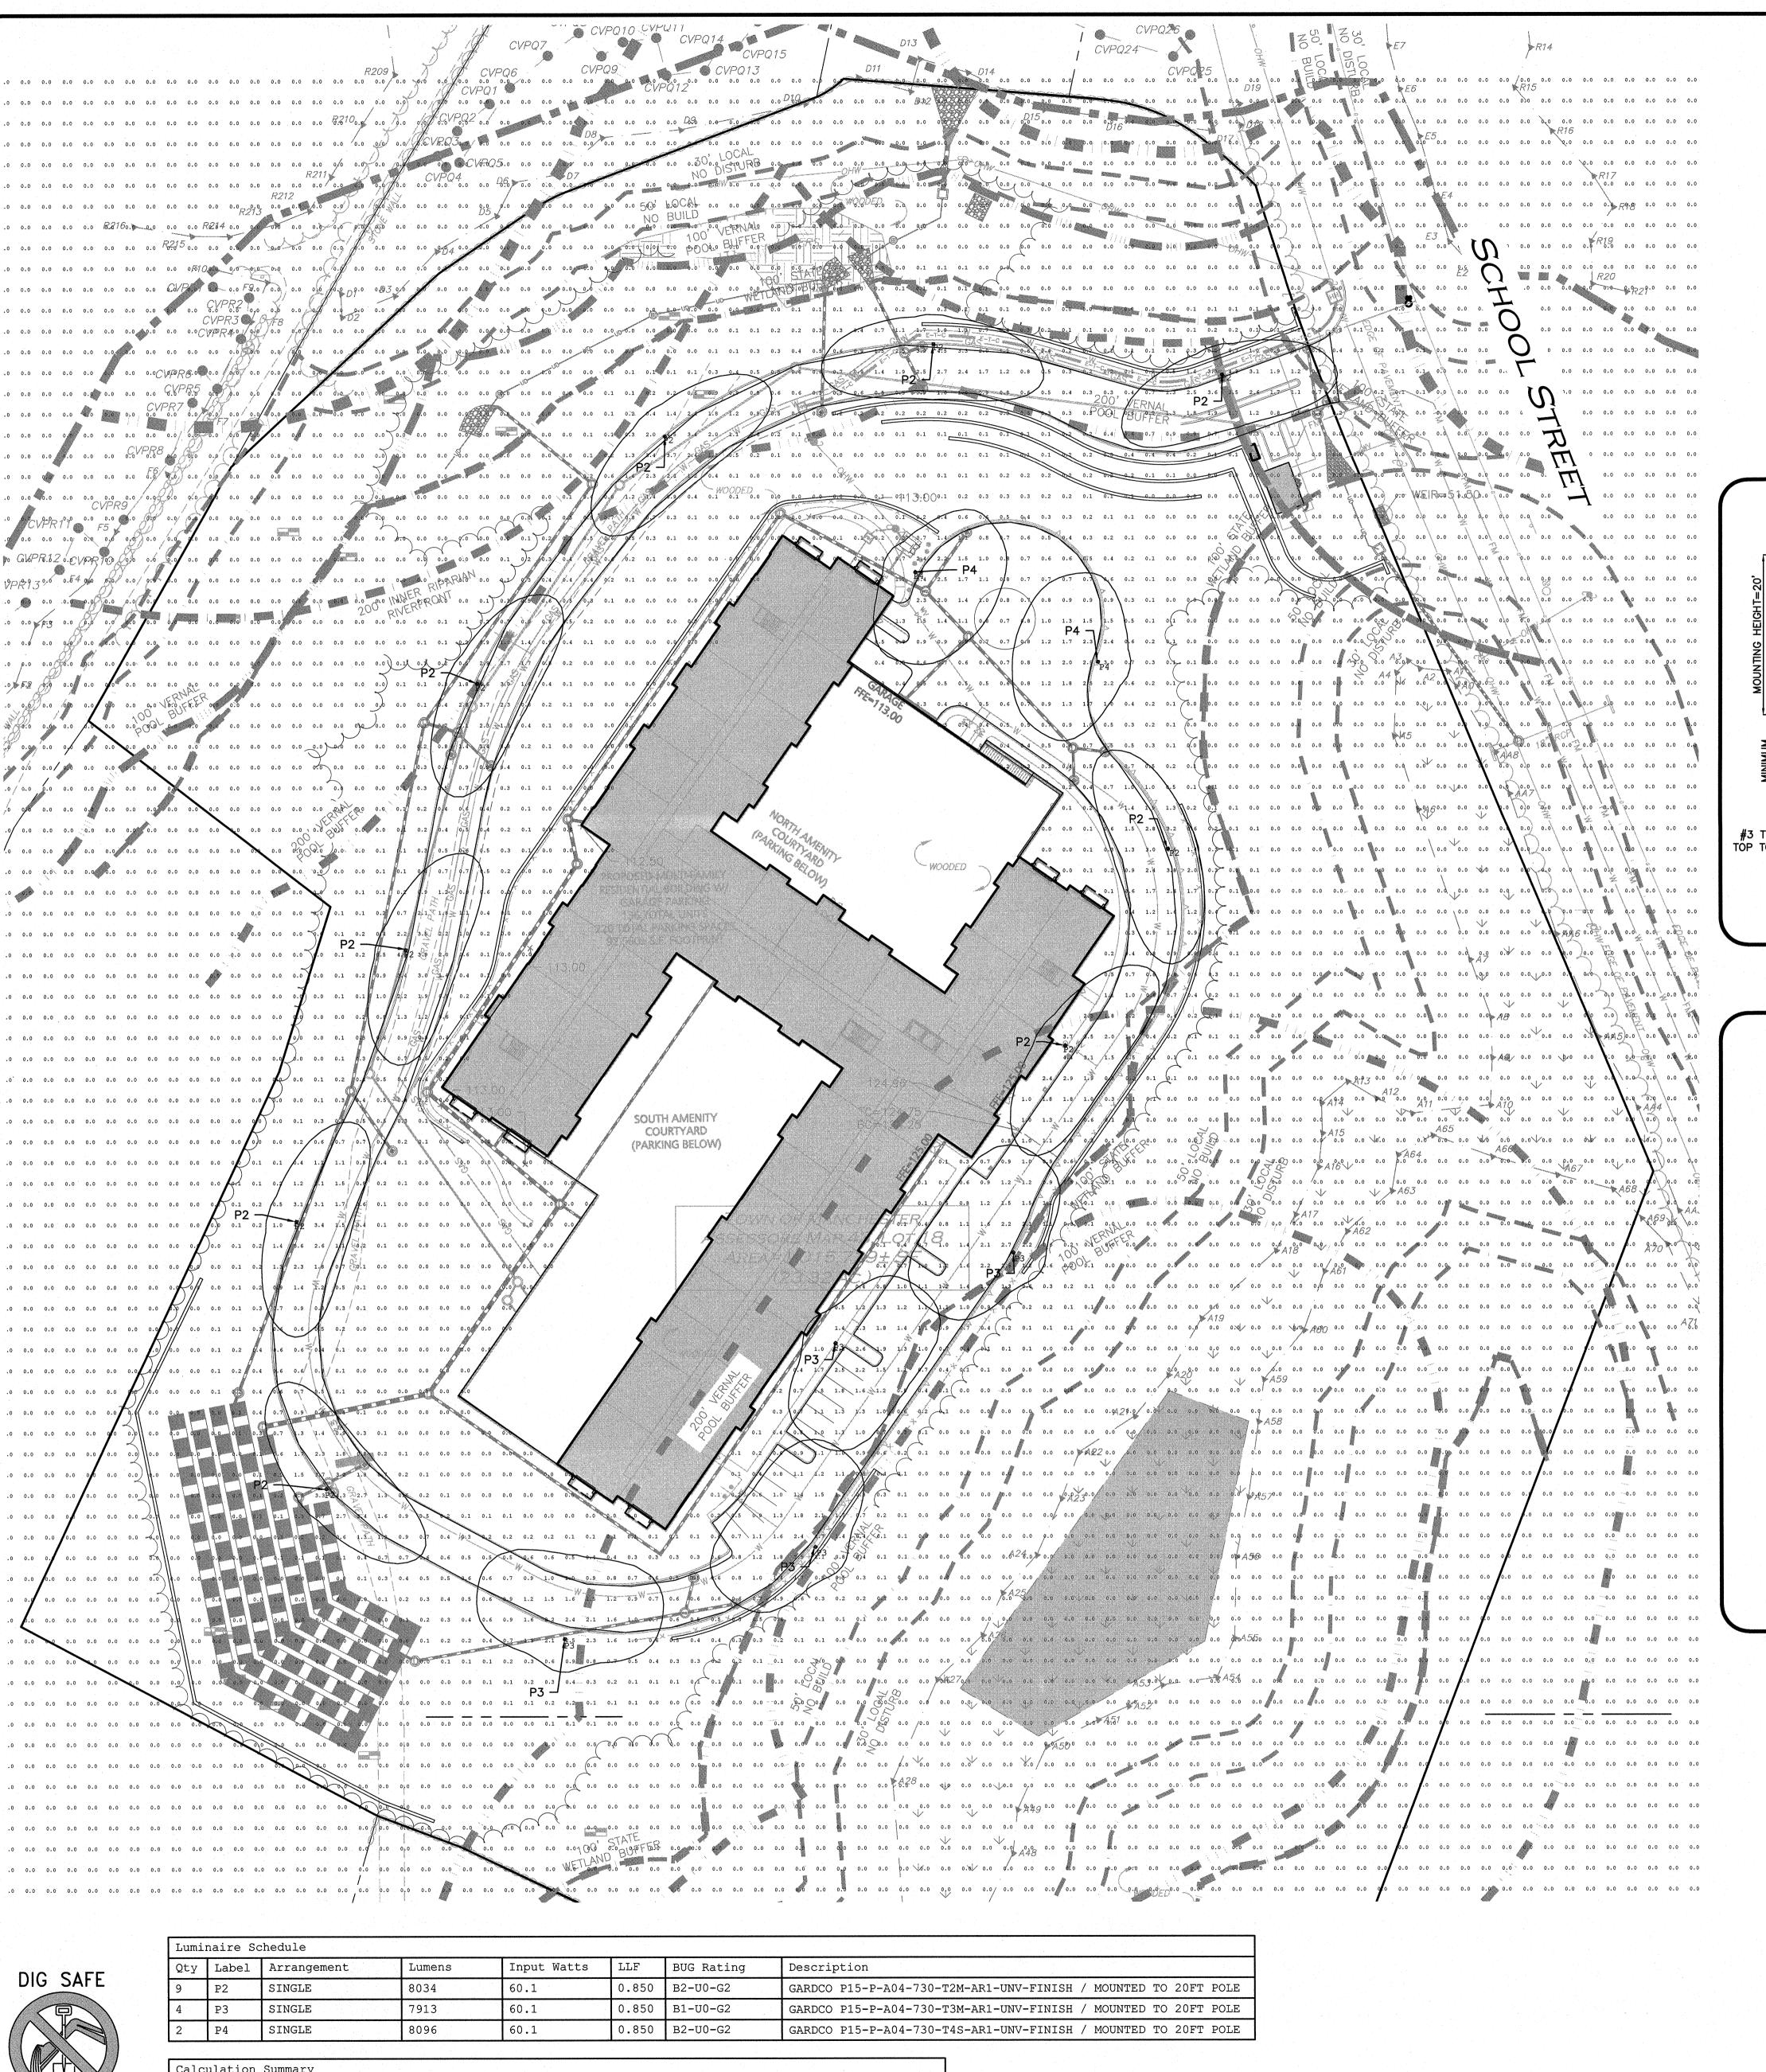
1"=40' DWG. NAME: C-2725-01


07-16-2021

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C-104


UTILITIES PLAN




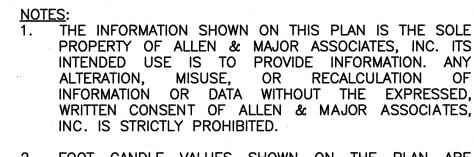

FOOT CANDLE VALUES SHOWN ON THE PLAN ARE PRODUCED UTILIZING DESIGN MASTER PHOTOMETRICS SOFTWARE AND ASSOCIATED IES FILES BY THE MANUFACTURER FOR THE PROPOSED LIGHT FIXTURE.

- ALL PHOTOMETRIC DATA REFERS TO UNITS IN FOOT CANDLES (FC). THE LIMIT OF 1.0 FC ILLUMINATION IS SHOWN IN A RED SOLID LINE AND THE LIMIT OF THE 0.5 FOOT CANDLE (FC) ILLUMINATION IS SHOWN IN
- 4. ALL POST-TOP AND WALL-MOUNTED LIGHTS ON THE SITE SHALL USE HIGH-EFFICIENCY LED BULBS.
- CONTRACTOR SHALL SUBMIT SHOP DRAWINGS FOR APPROVAL PRIOR TO INSTALLATION OF LIGHTS.

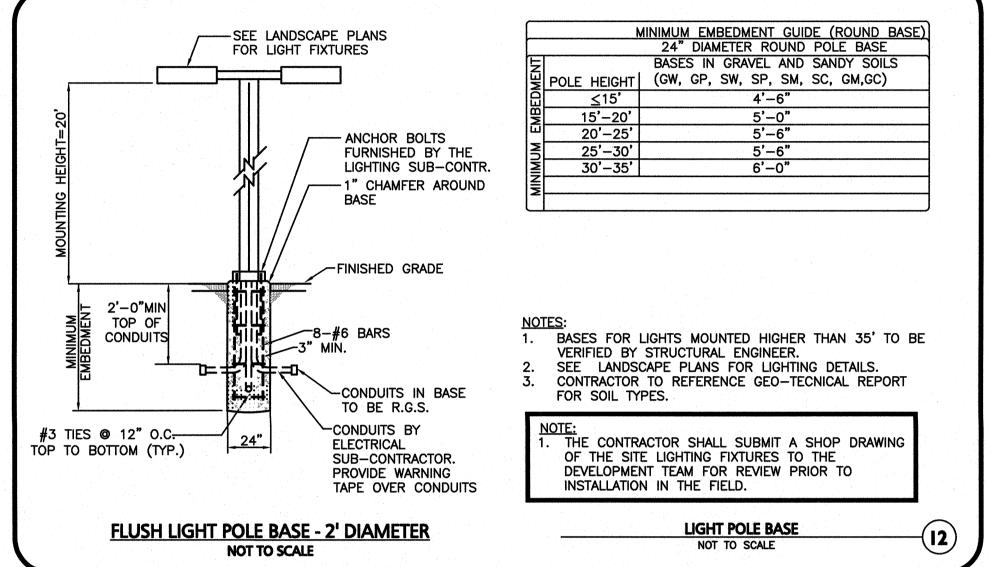


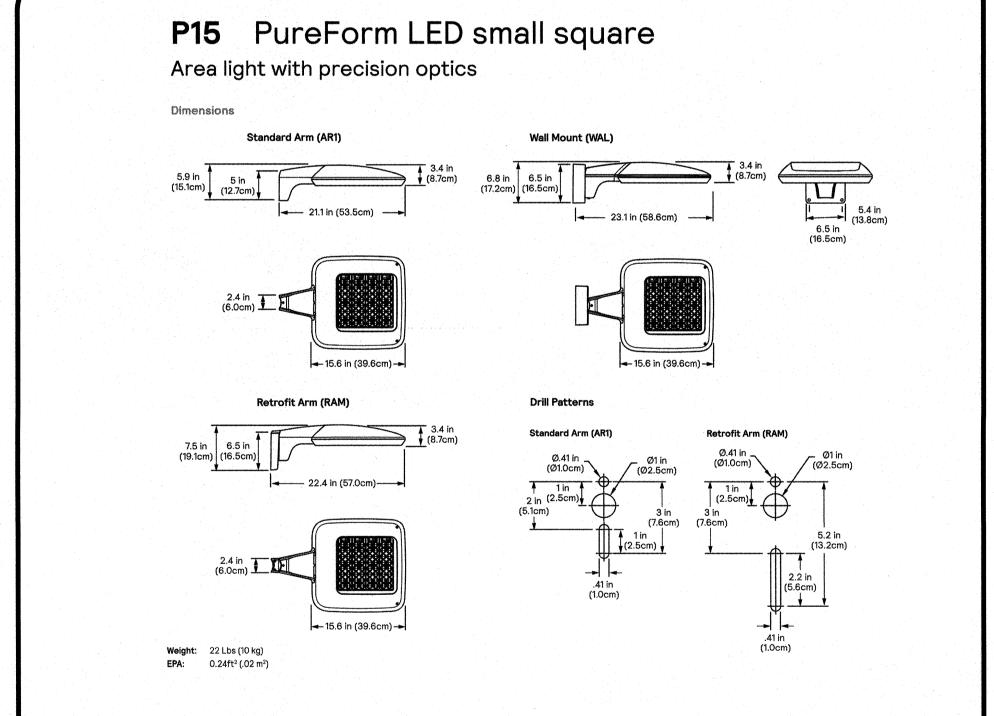




1-888-344-7233

Calculation Summary						
Label	Grid Height	Avg	Max	Min	Avg/Min	Max/Min
CalcPts_1	0	0.15	4.6	0.0	N.A.	N.A.
PARKING AND DRIVING LANE		1.18	4.5	0.2	5.90	22.50

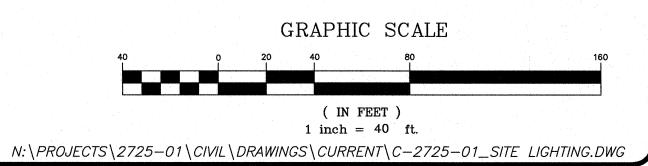

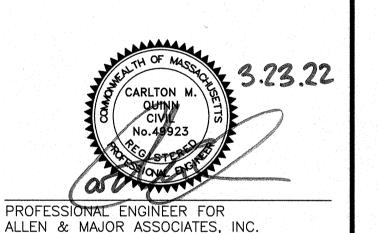

A 03-23-2022 REVISED PER COMMENTS

SLV SCHOOL STREET, LLC

257 HILLSIDE AVENUE NEEDHAM, MA 02494

THE SANCTUARY SCHOOL STREET MANCHESTER-BY-THE-SEA, MA

			·
PROJECT NO.	2725-01	DATE:	07-16-2021
SCALE:	1"=40'	DWG. NAME:	C-2725-01
DESIGNED BY:	CMQ/SJL	CHECKED BY:	СМQ
PREPARED BY:			



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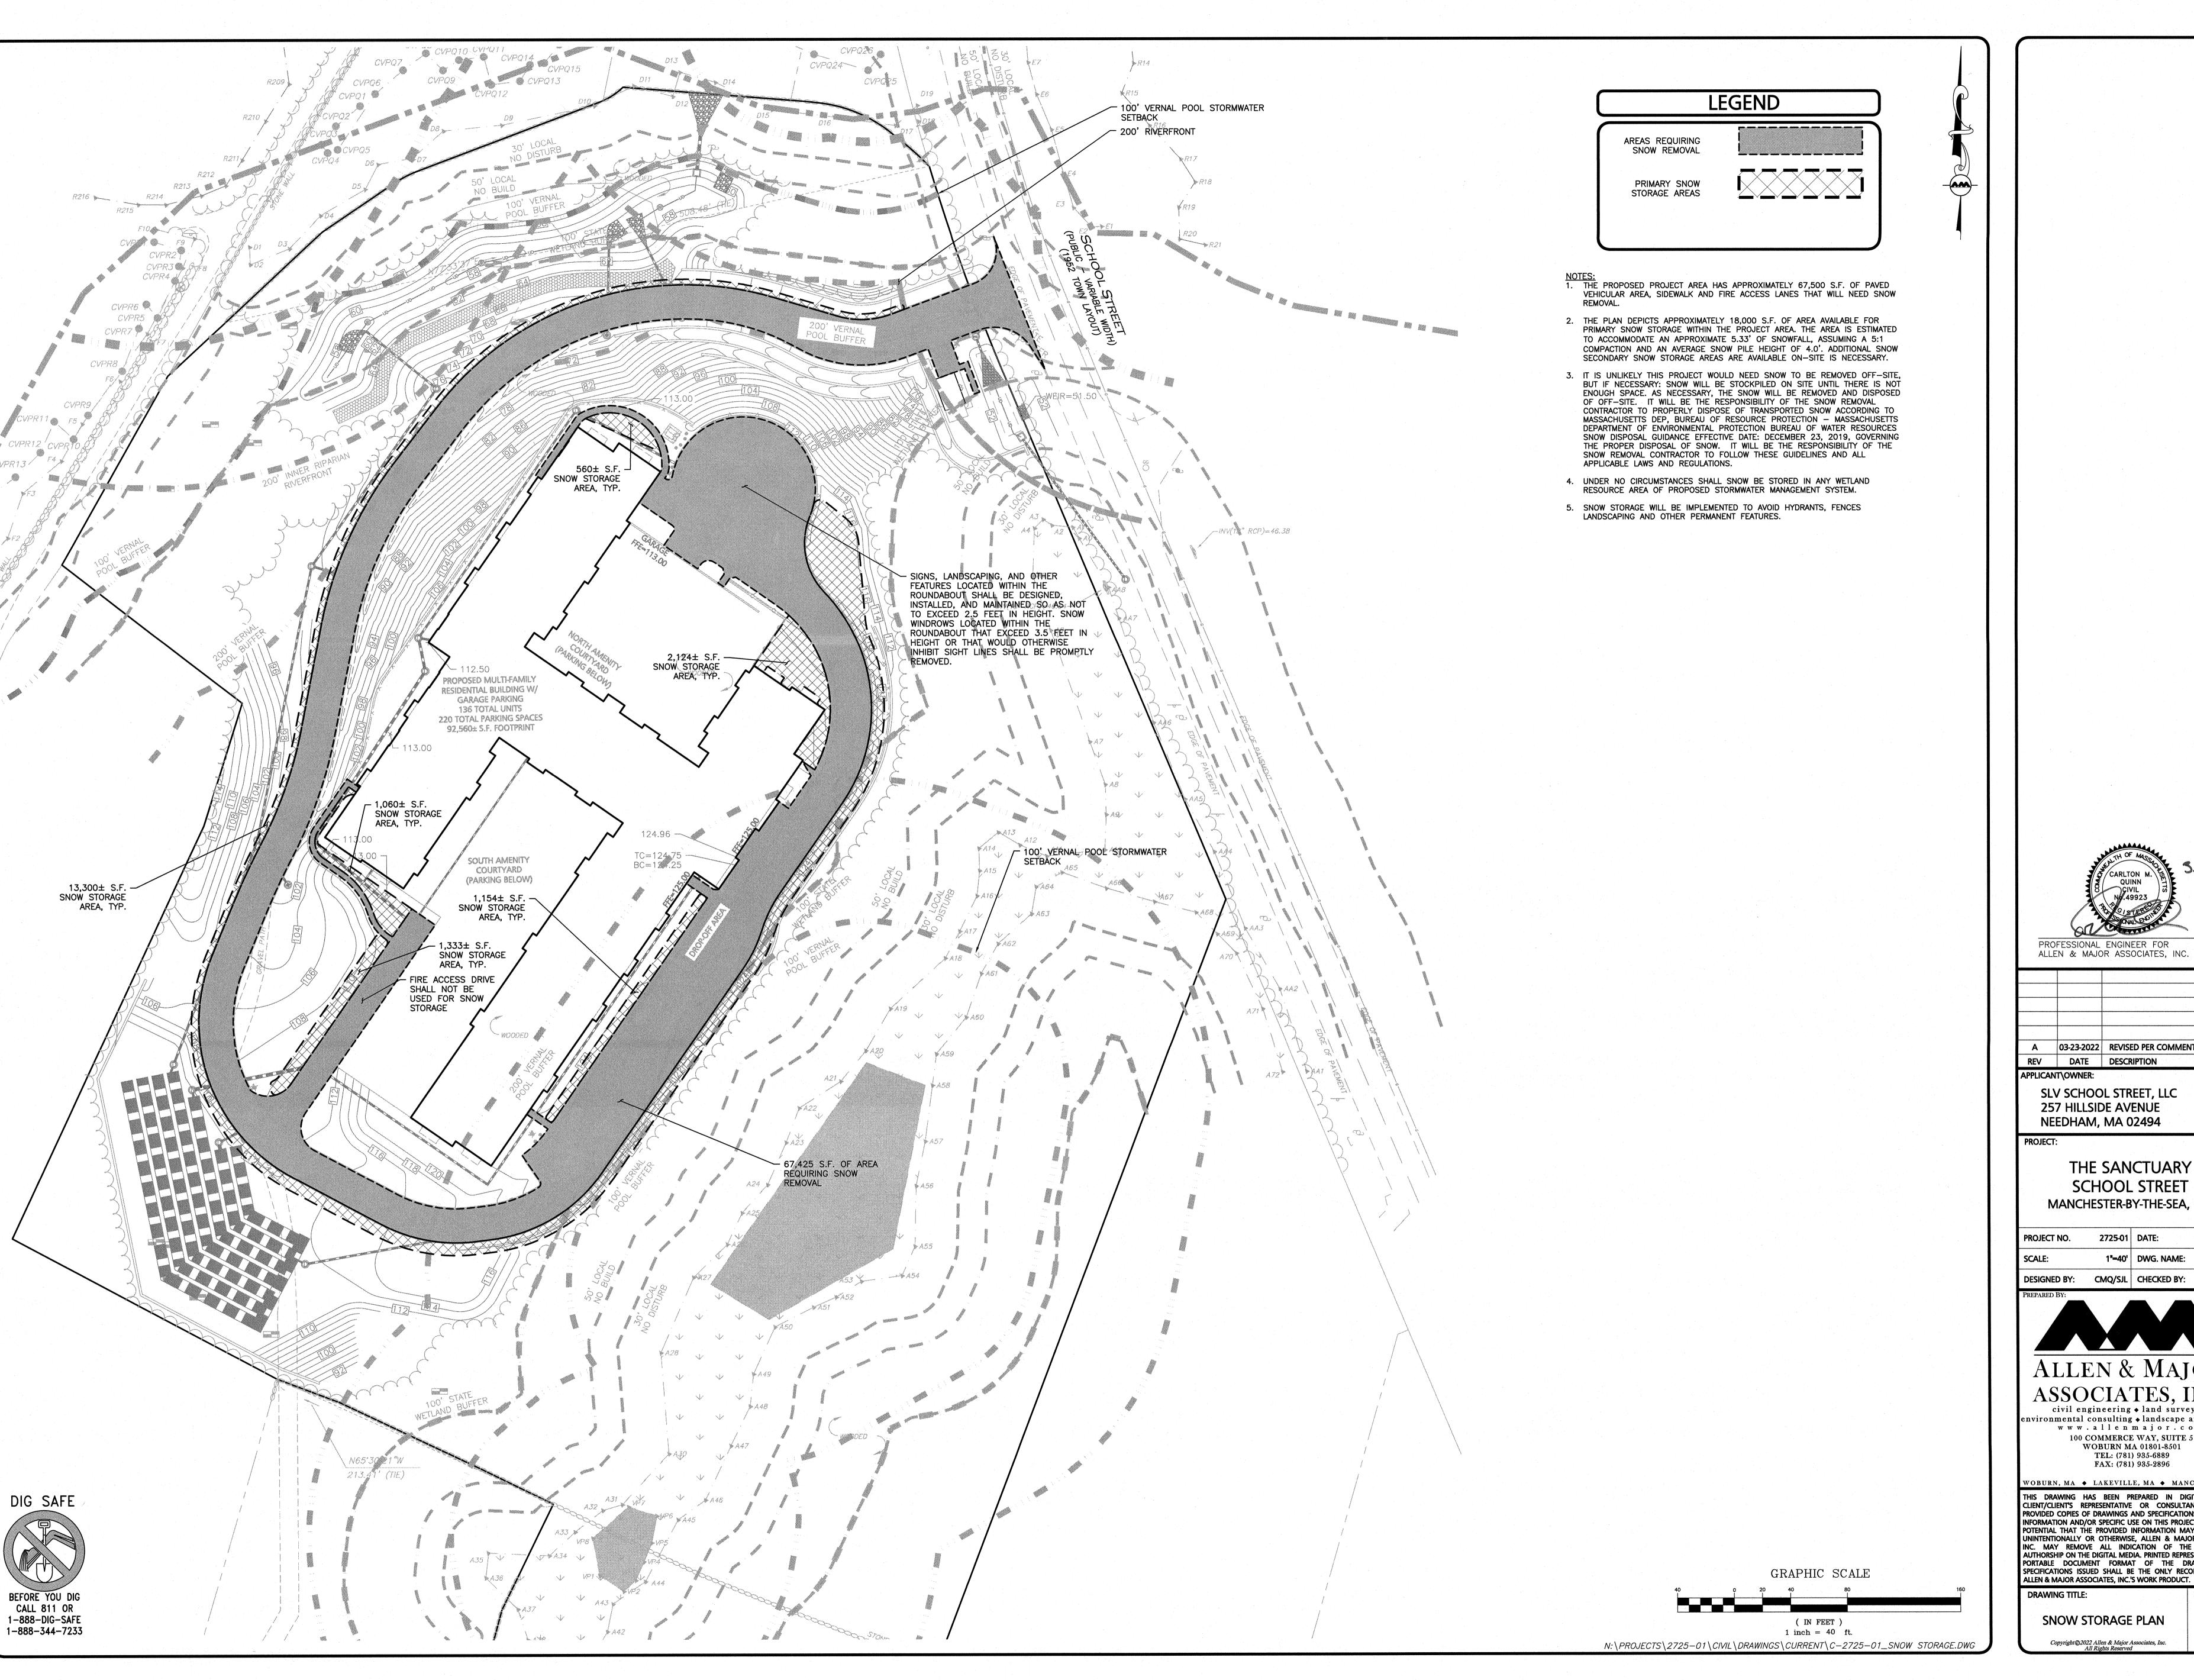
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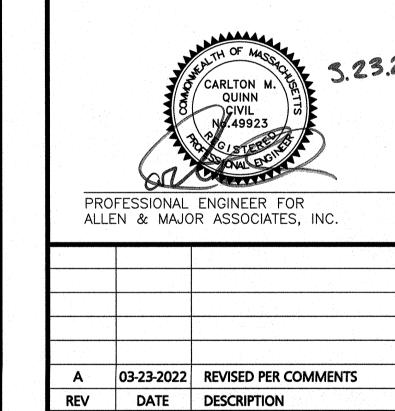
SPECIFICATIONS ISSUED SHALL BE THE ONLY RECORD COPIES O

SHEET No.

C-105 SITE LIGHTING PLAN

ALLEN & MAJOR ASSOCIATES, INC.'S WORK PRODUCT.





NEEDHAM, MA 02494 THE SANCTUARY

SLV SCHOOL STREET, LLC 257 HILLSIDE AVENUE

MANCHESTER-BY-THE-SEA, MA

SCHOOL STREET





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DRAWING TITLE: C-106 SNOW STORAGE PLAN





PROFESSIONAL ENGINEER FOR ALLEN & MAJOR ASSOCIATES, INC.

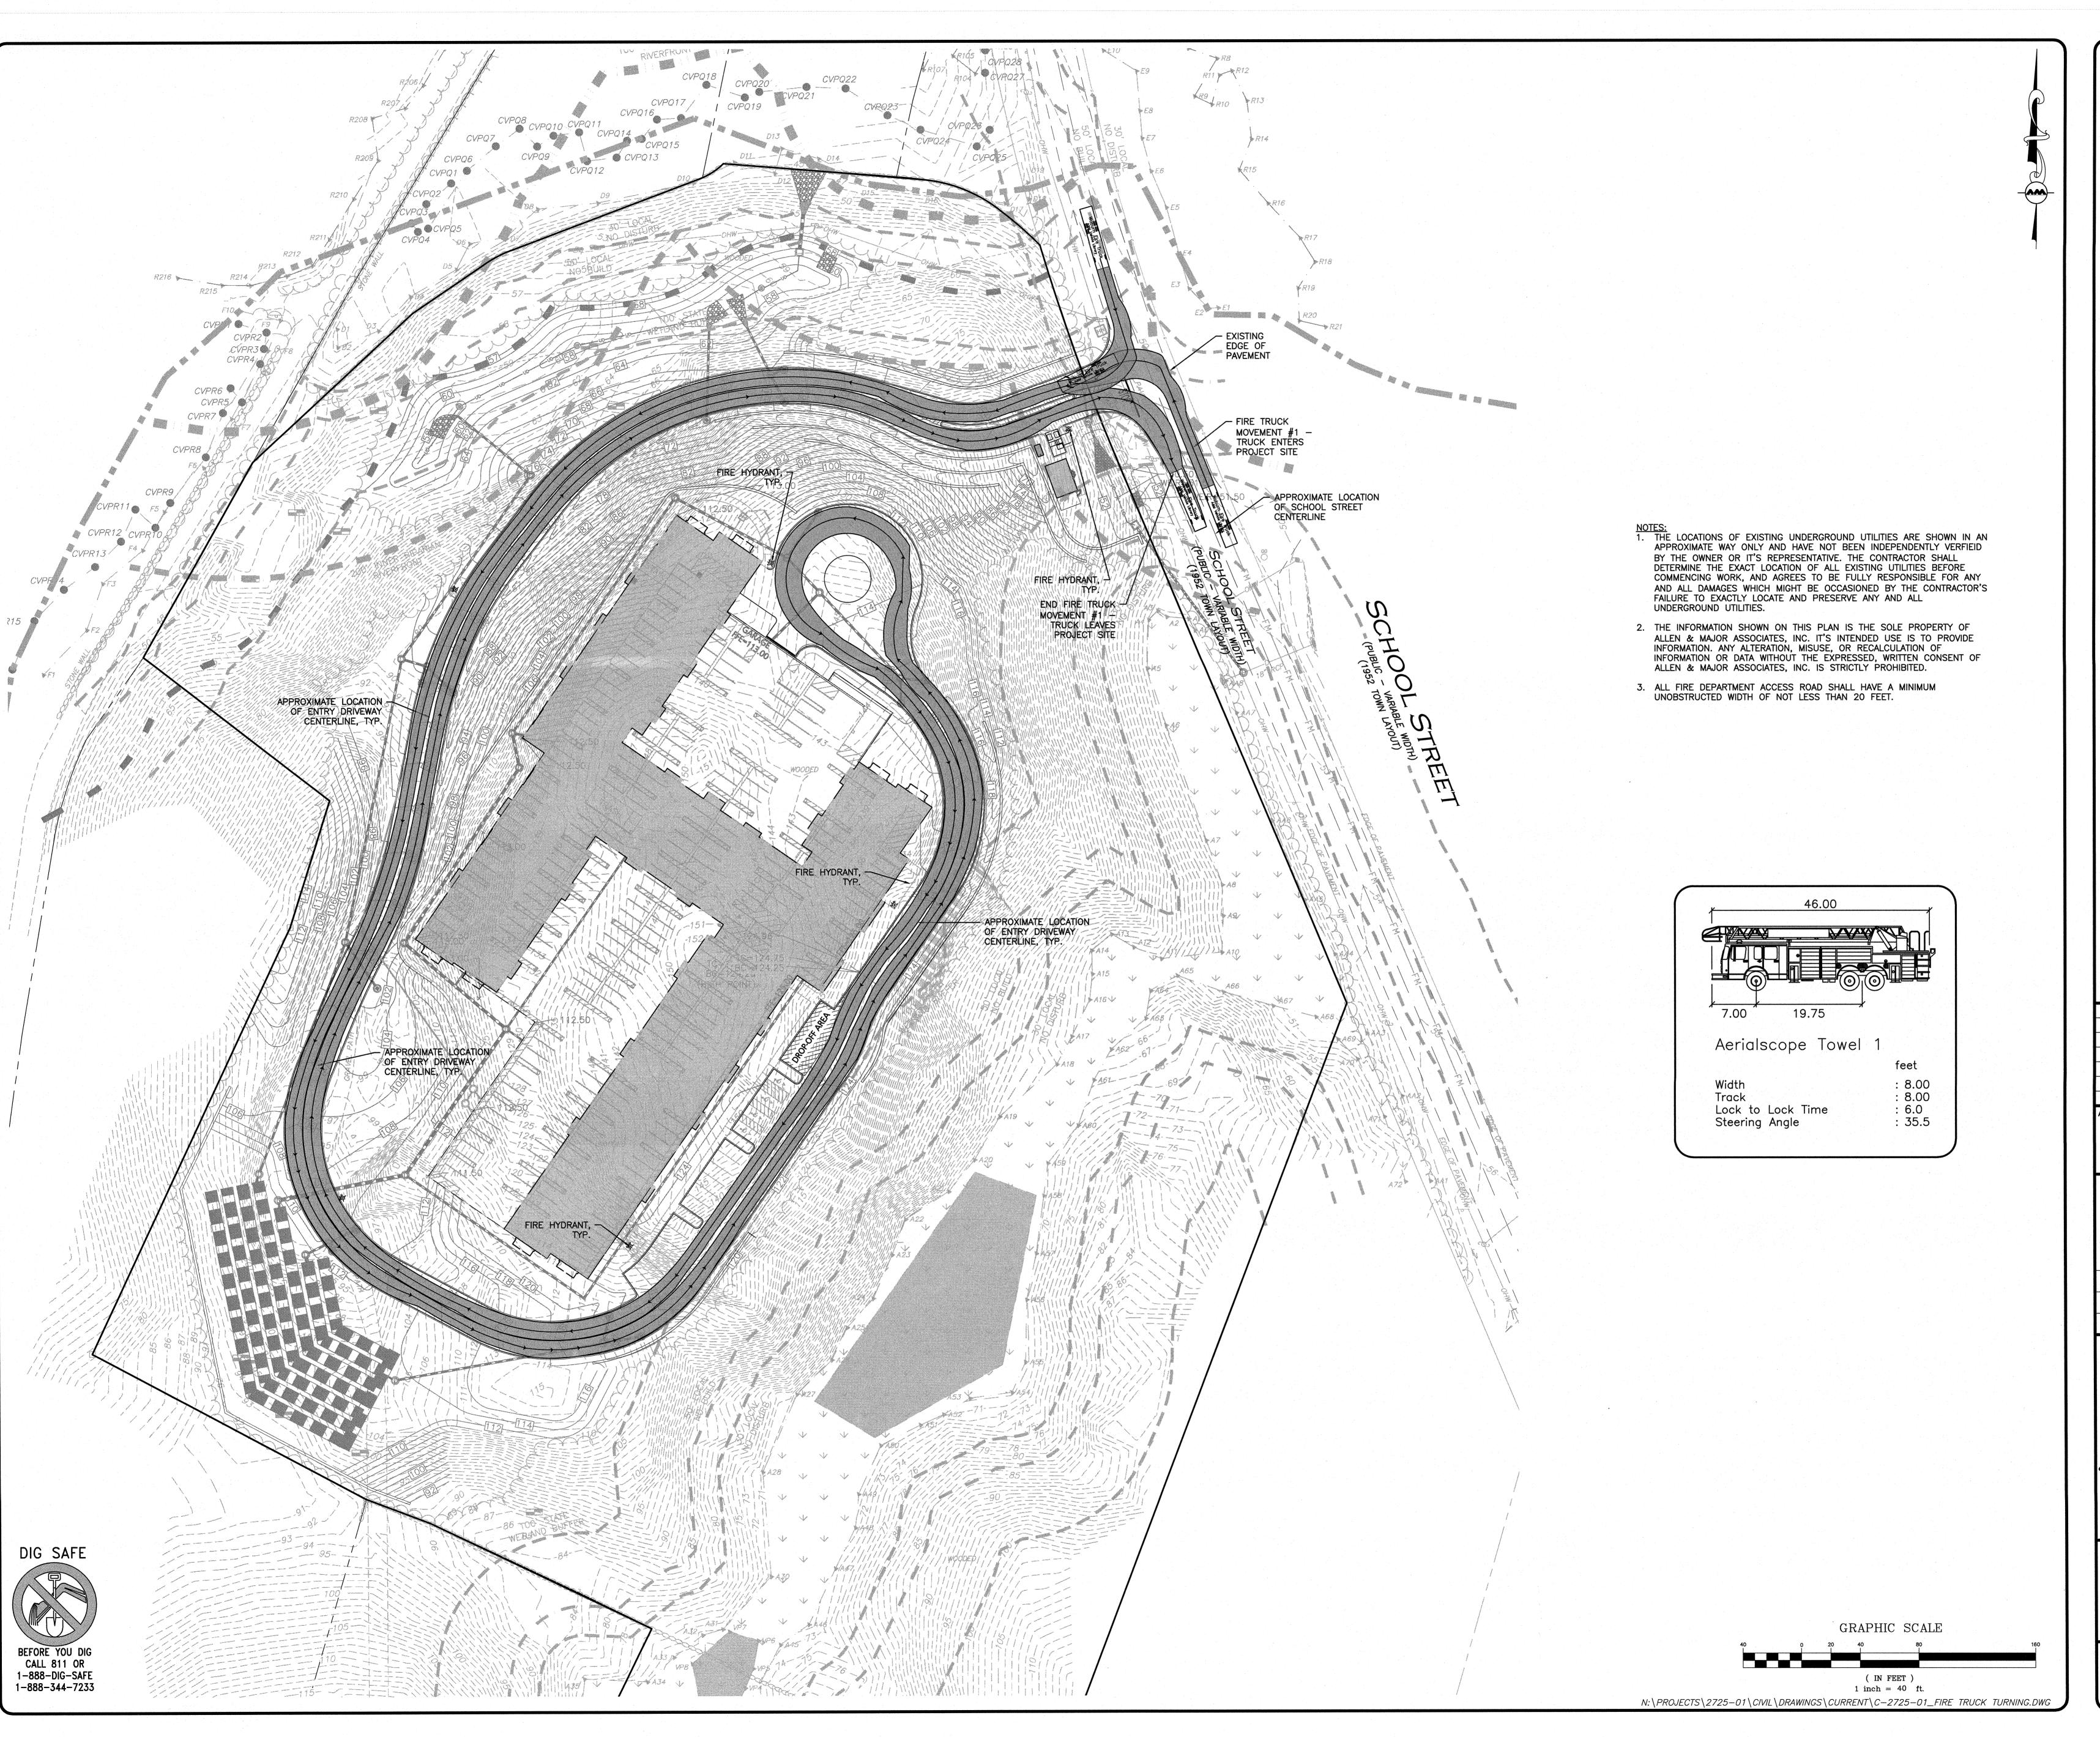- , ,	- ATT	DECCRIPTION
4	03-23-2022	REVISED PER COMMENTS

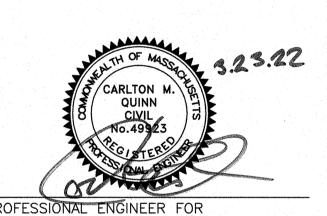SLV SCHOOL STREET, LLC 257 HILLSIDE AVENUE NEEDHAM, MA 02494

PROJECT

THE SANCTUARY
SCHOOL STREET
MANCHESTER-BY-THE-SEA, MA

PROJECT NO.	2/25-01	DAIE.	07-10-20
 SCALE:	1"=40'	DWG. NAME:	C-2725-
DESIGNED BY:	CMQ/SJL	CHECKED BY:	CM
PREPARED BY:			



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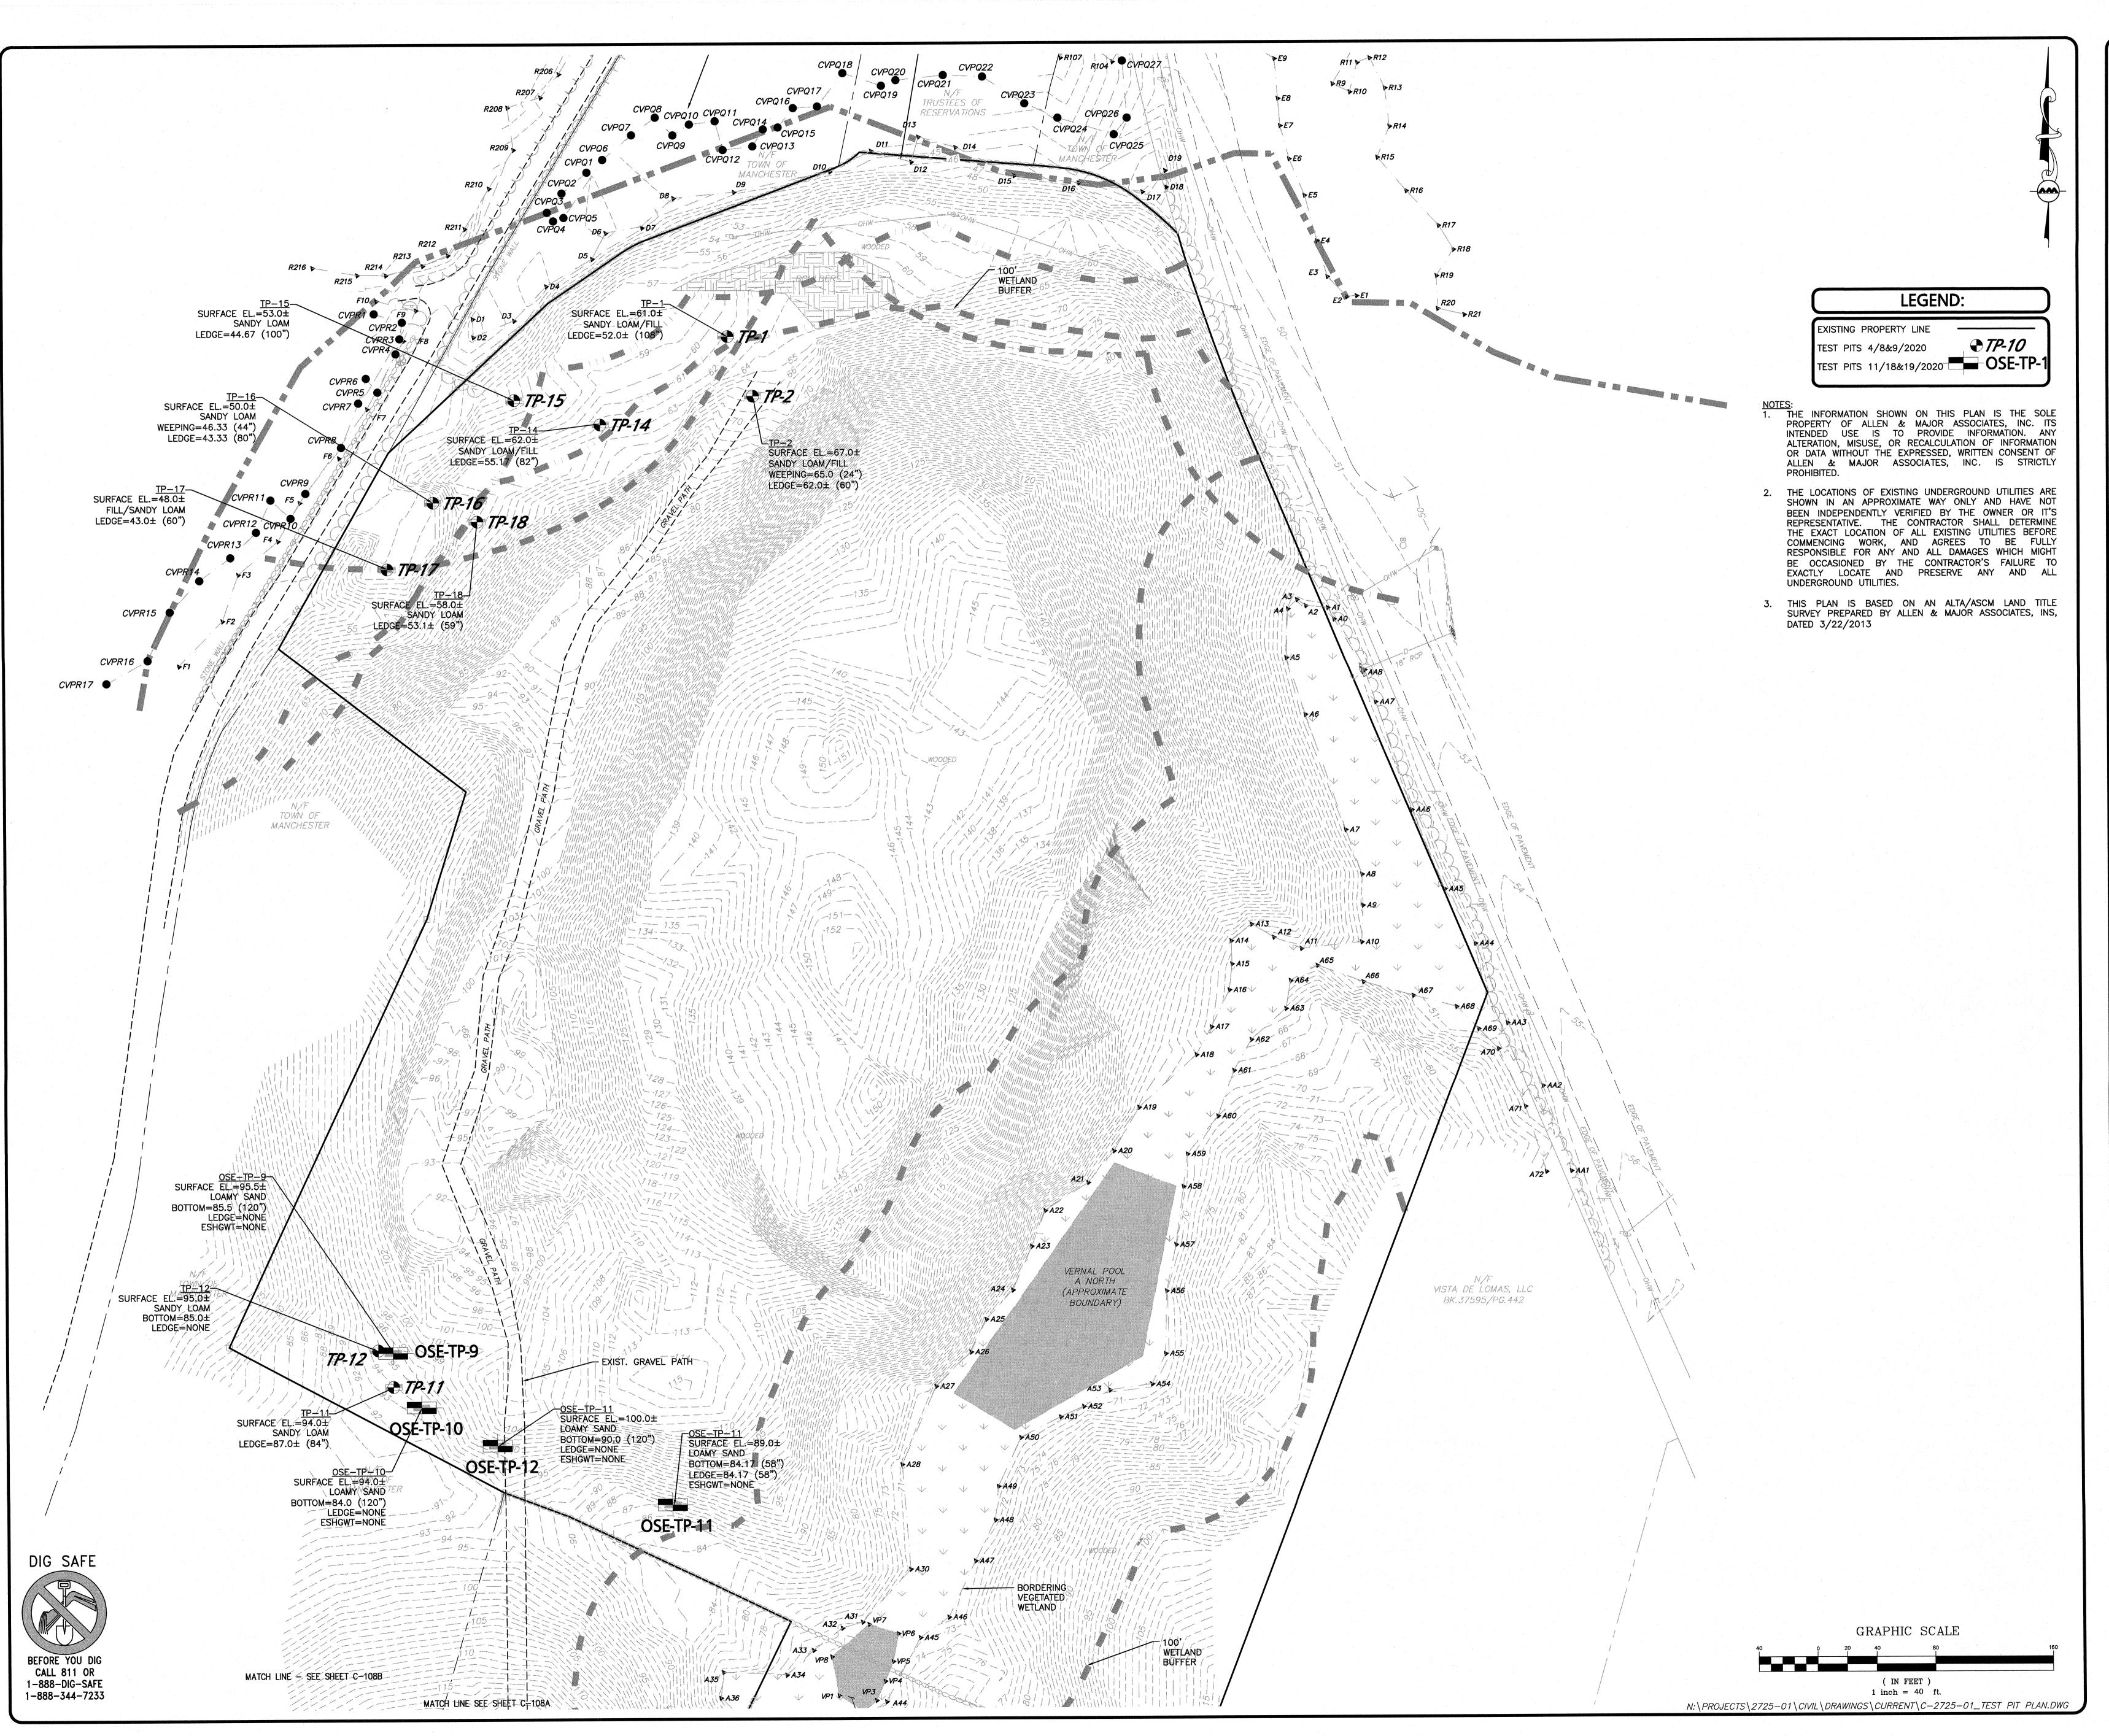
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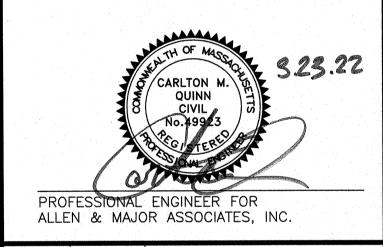
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C-107

FIRE TRUCK TURNING





A 03-23-2022 REVISED PER COMMENTS

REV DATE DESCRIPTION

SLV SCHOOL STREET, LLC 257 HILLSIDE AVENUE NEEDHAM, MA 02494

PROJECT:

THE SANCTUARY
SCHOOL STREET
MANCHESTER-BY-THE-SEA, MA

PROJECT NO. 2725-01 DATE: 07-16-26

SCALE: 1"=40' DWG. NAME: C-2725

DESIGNED BY: CMQ/SJL CHECKED BY: CI



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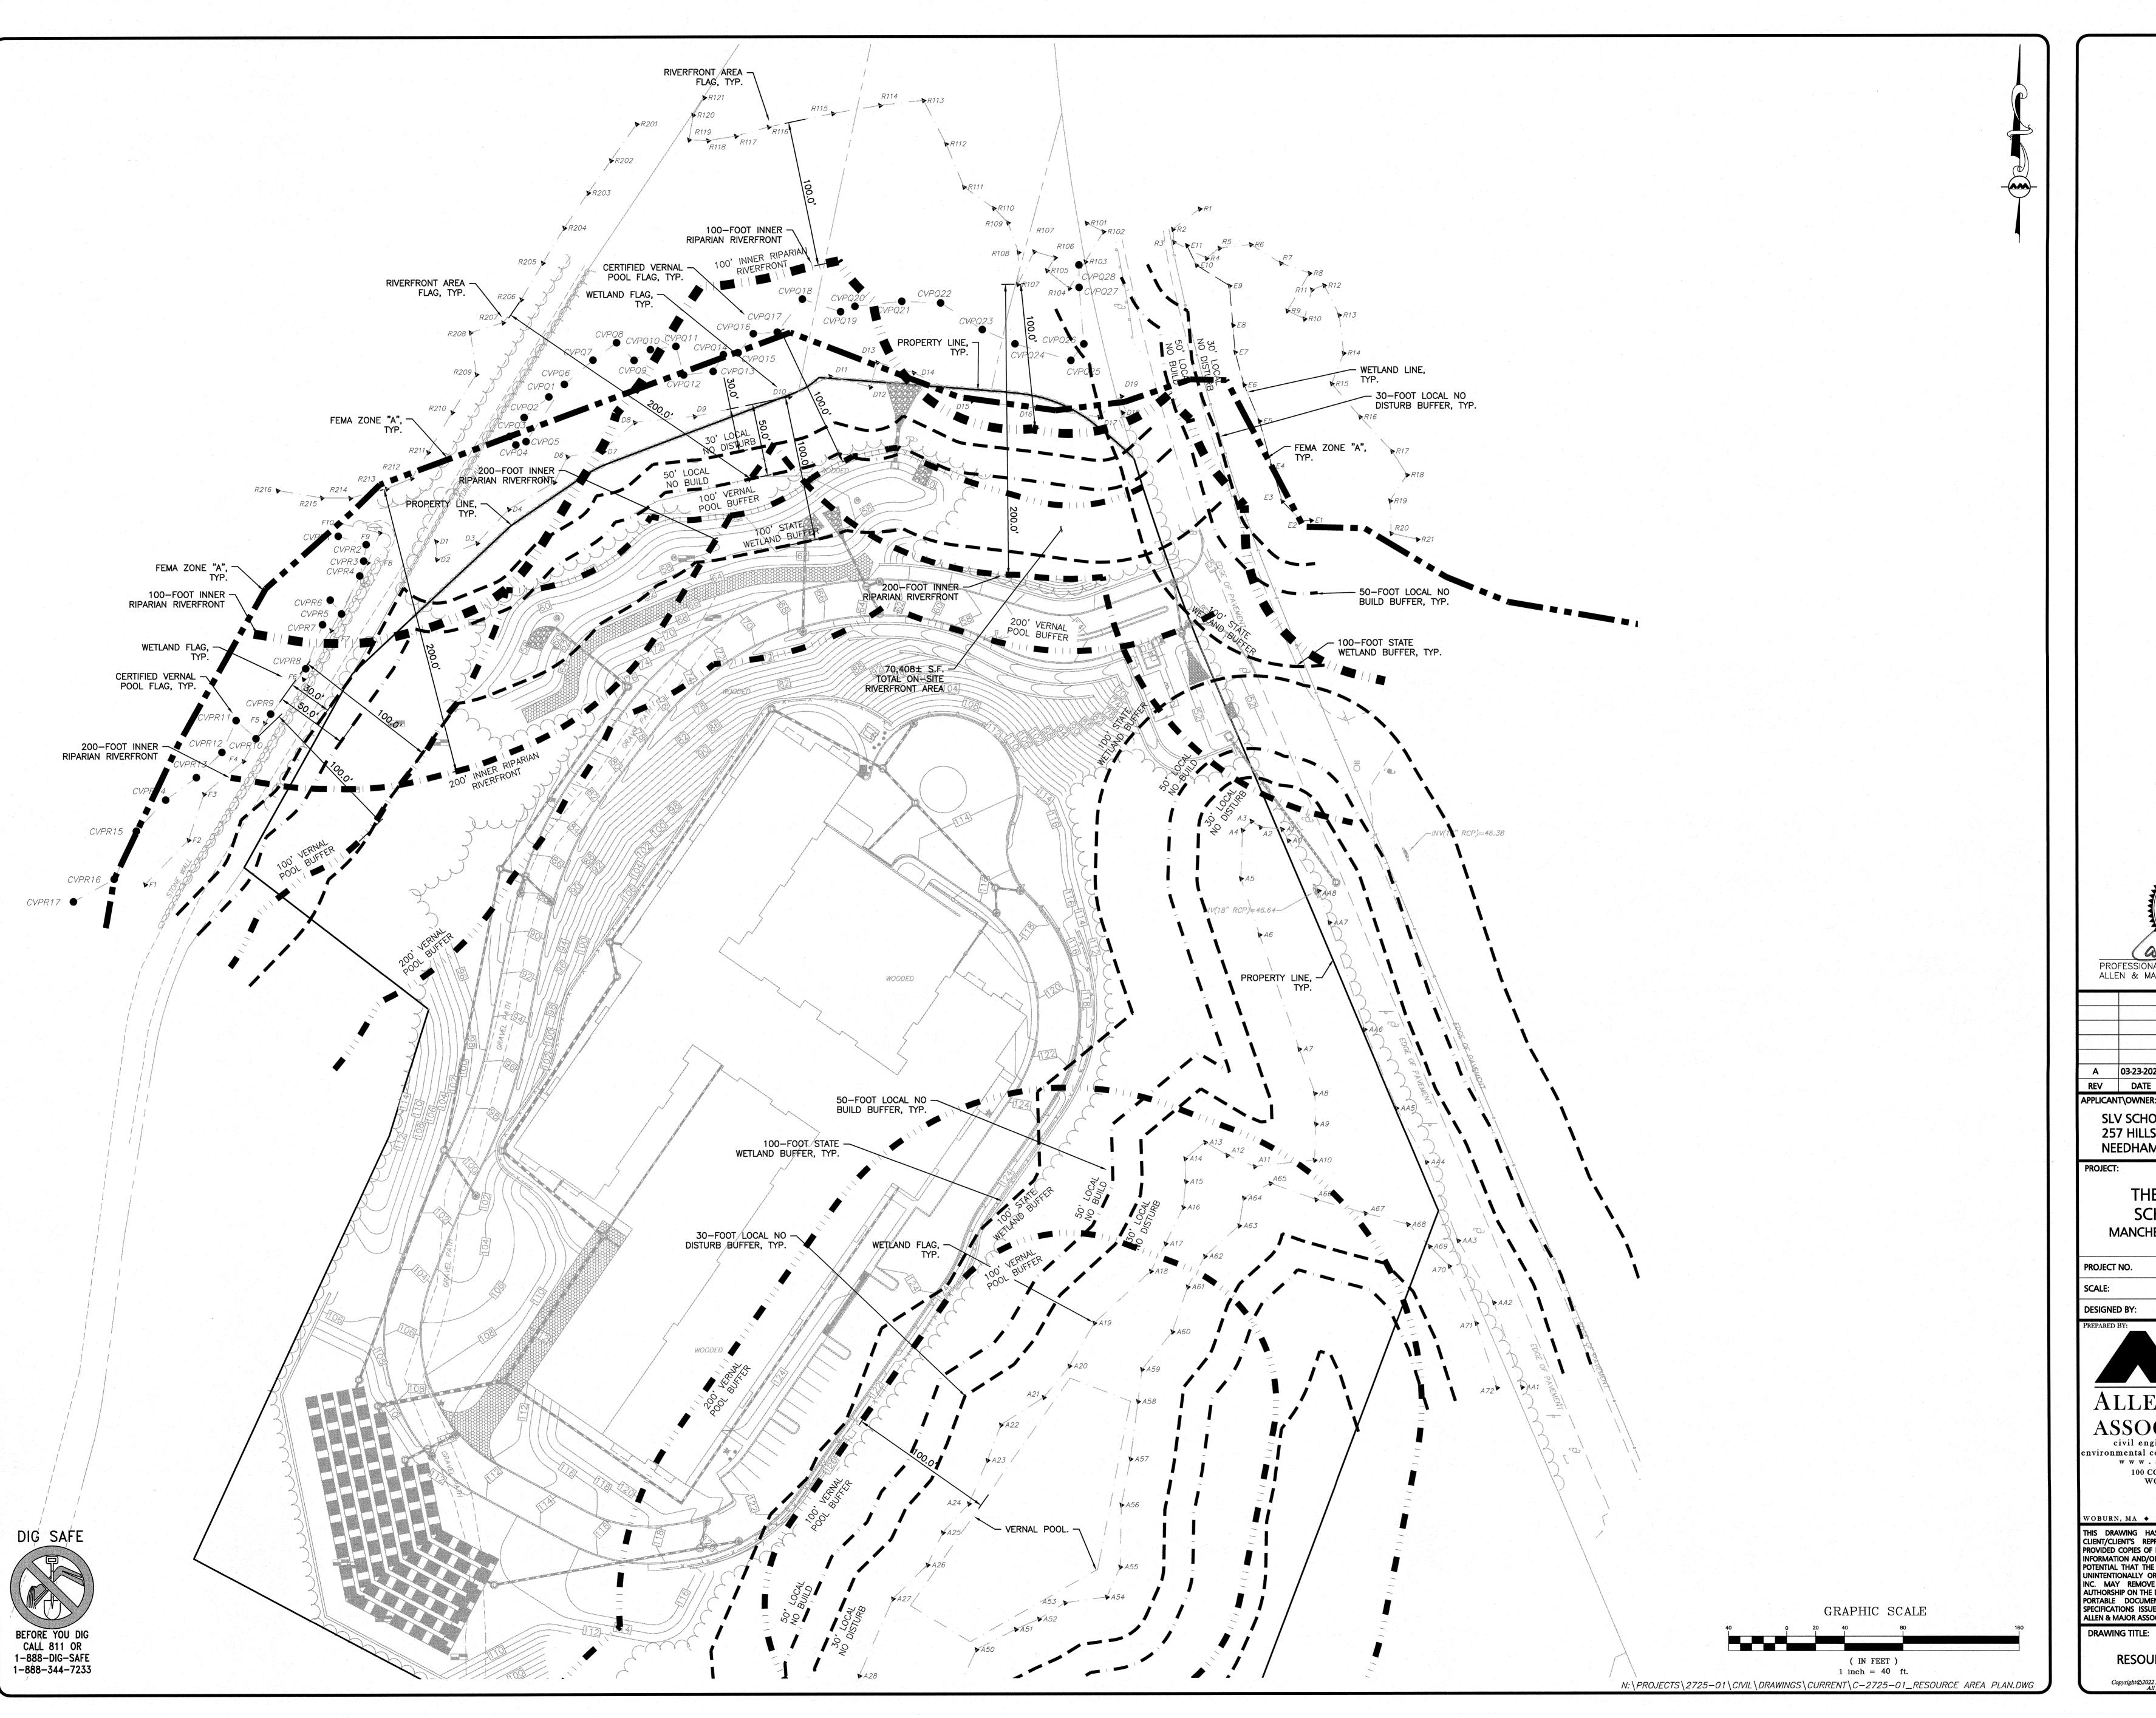
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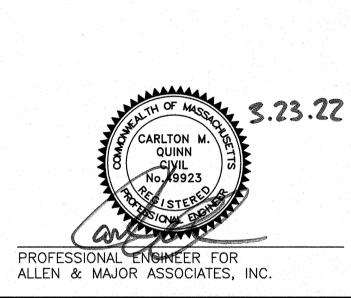
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TEST PIT PLAN





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REV DATE DESCRIPTION

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THE SANCTUARY
SCHOOL STREET
MANCHESTER-BY-THE-SEA, MA

PROJECT NO. 2725-01 DATE: 07-16-202

SCALE: 1"=40' DWG. NAME: C-2725-0

DESIGNED BY: CMQ/SJL CHECKED BY: CMC

PREPARED BY:



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FAX: (781) 935-2896


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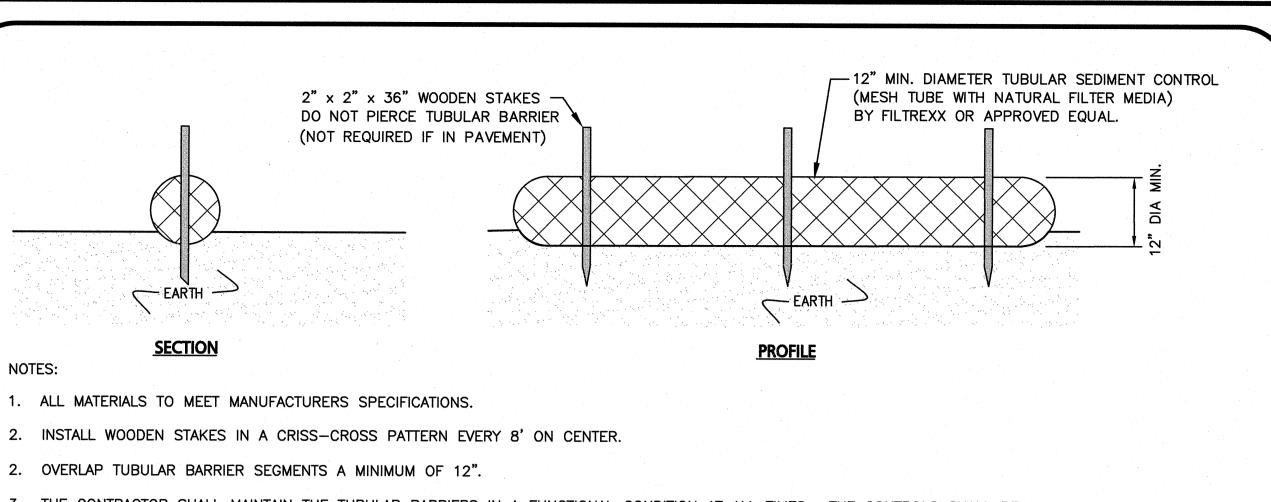
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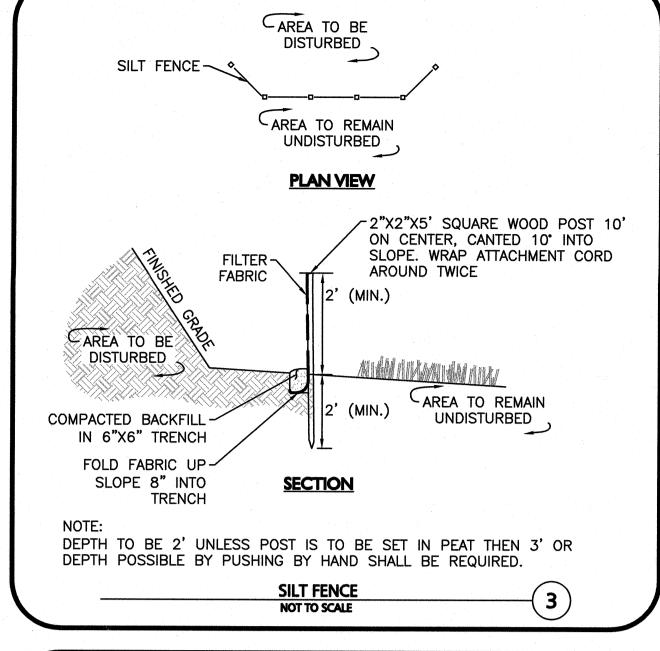
C-109







- 3. THE CONTRACTOR SHALL MAINTAIN THE TUBULAR BARRIERS IN A FUNCTIONAL CONDITION AT ALL TIMES. THE CONTROLS SHALL BE ROUTINELY INSPECTED BY THE CONTRACTOR.
- WHERE THE TUBULAR BARRIERS REQUIRE REPAIR OR SEDIMENT REMOVAL, IT WILL BE COMPLETED BY THE CONTRACTOR AT NO ADDITIONAL COST.
- 5. AT A MINIMUM, THE CONTRACTOR SHALL REMOVE SEDIMENTS COLLECTED AT THE BASE WHEN THEY REACH 1/3 THE EXPOSED HEIGHT OF THE BARRIER.


TUBULAR SEDIMENT BARRIER DETAIL NOT TO SCALE

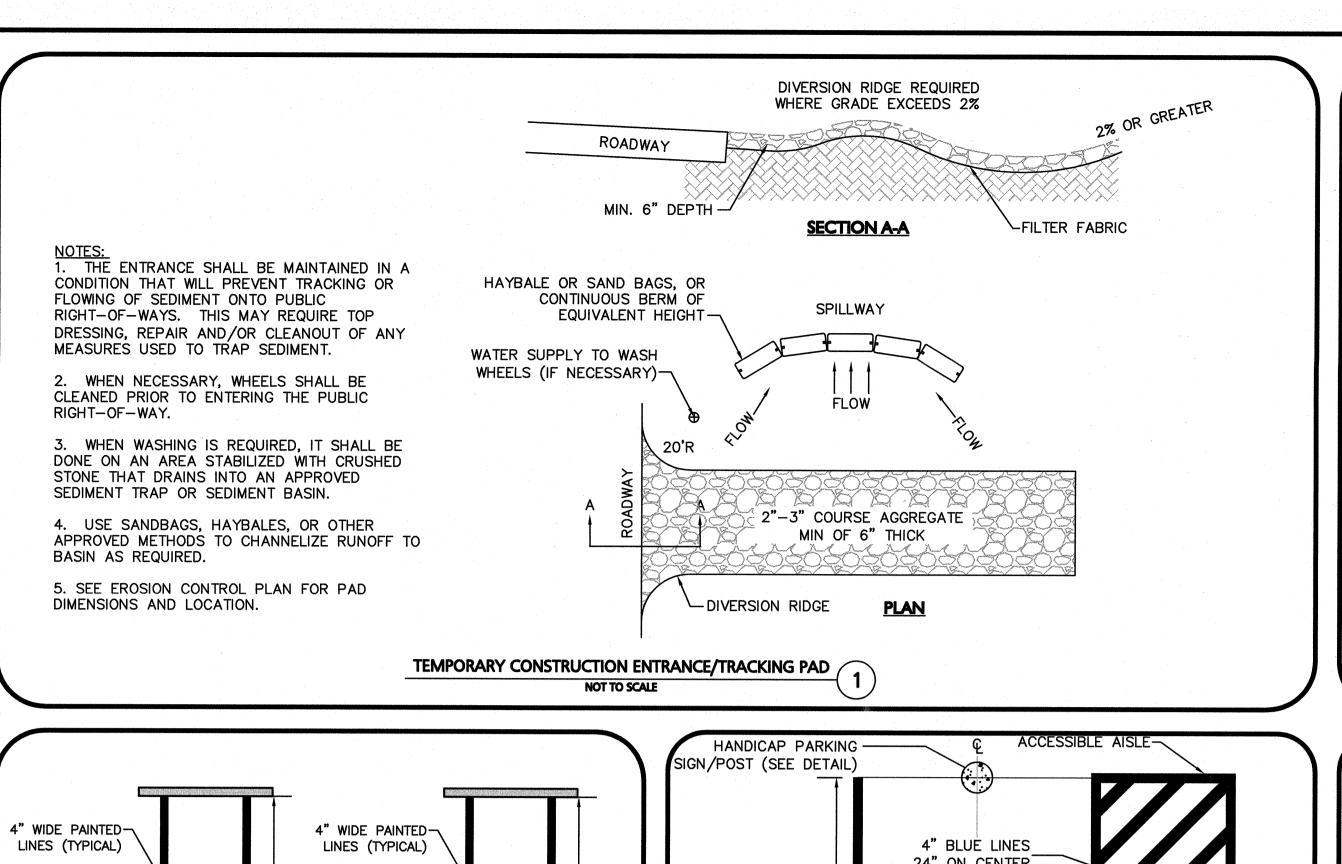


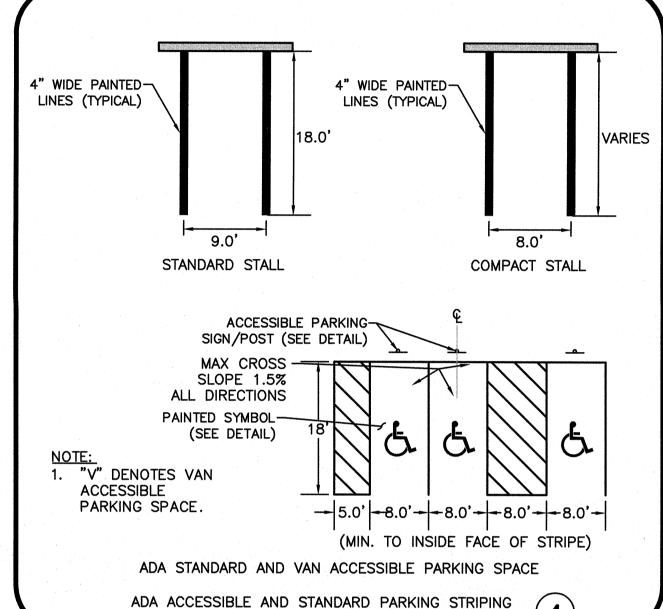

NOT TO SCALE

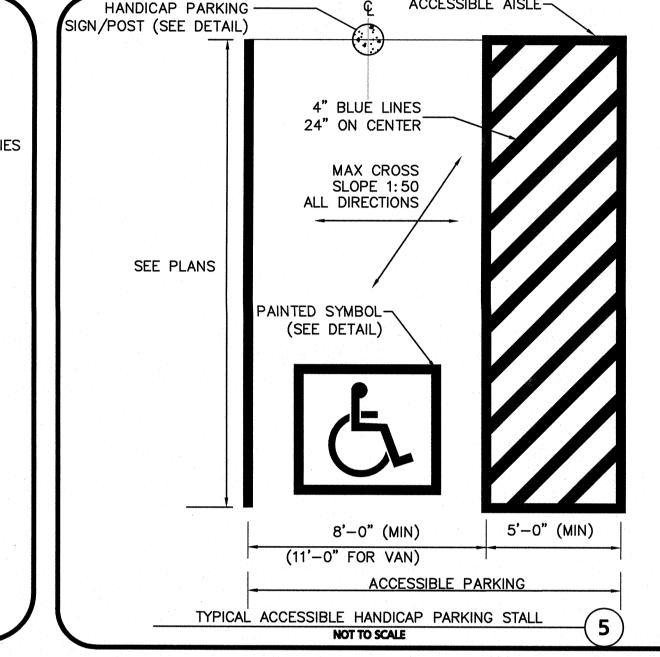


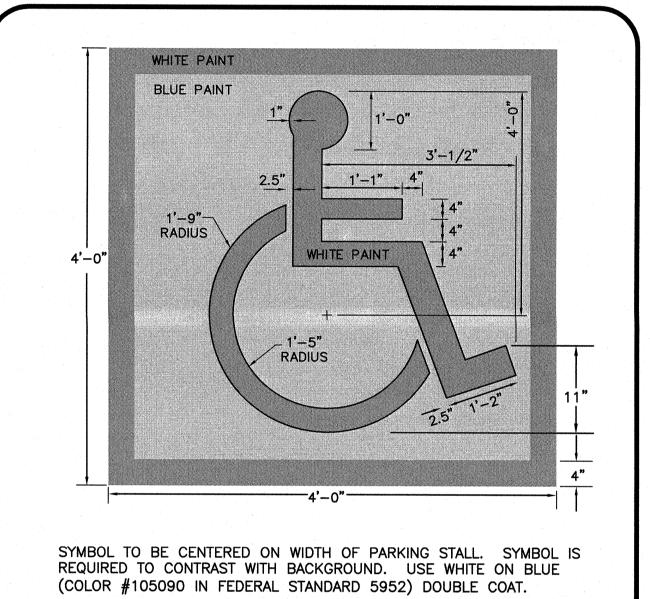


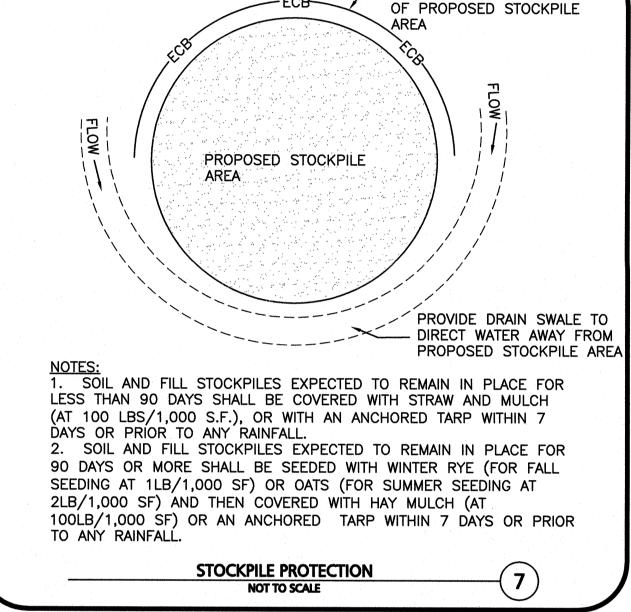


-EROSION CONTROL BARRIER

INSTALLED DOWN SLOPE

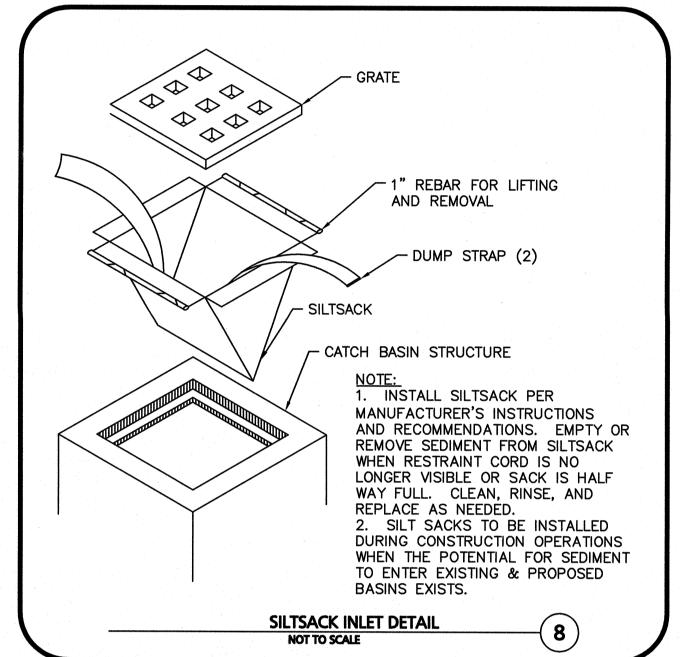

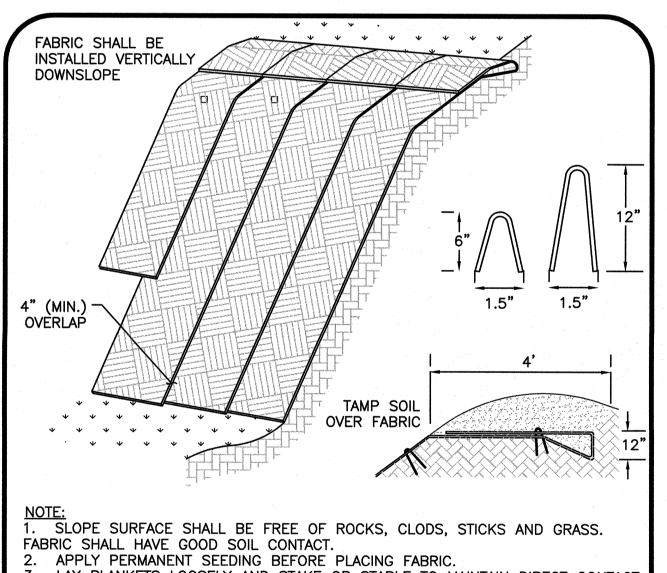

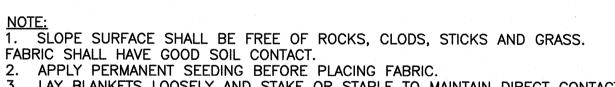

3. LAY BLANKETS LOOSELY AND STAKE OR STAPLE TO MAINTAIN DIRECT CONTACT WITH THE SOIL. DO NOT STRETCH. 4. CHOOSE MATERIAL BASED ON SLOPE, SOILS, AND APPLICATION.

(MIN)

12"x24"


12"x18"

NUMBER

R7-8(M)

(MODIFIED)

R7-8

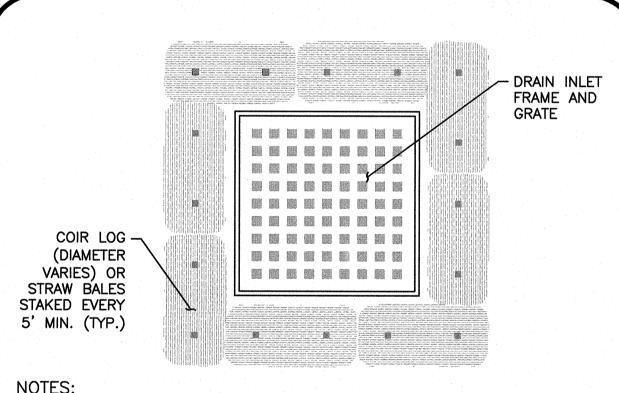

STRAW BALES SHALL BE POSITIONED IN A ROW SO THAT EACH END TIGHTLY ABUTTS THE ADJACENT BALE.

2. BALES SHALL BE SECURELY ANCHORED IN PLACE BY STAKES OR RE-BARS DRIVEN THROUGH THE BALES. THE FIRST STAKE IN EACH BALE SHALL BE ANGLED TOWARD PREVIOUSLY LAID BALE TO FORCE BALES TOGETHER. 3. FREQUENT INSPECTIONS SHALL BE CONDUCTED AND REPAIR OR

REPLACEMENT SHALL BE MADE PROMPTLY IF NECESSARY.

TYPICAL STRAW BALE FILTER DETAIL


SEE TYPICAL PAVEMENT SECTION (WHERE APPLICABLE)— YELLOW "CAUTION" TAPE (TYPICAL— OVER EACH CONDUIT)	– SUITABLE BACKFILL MATERIAL
ENCASE IN SAND, OR AS REQUIRED PER UTILITY PROVIDER SPECIFICATIONS. 4"(x2) PVC	24" MIN. COVER
1. CONDUITS SHALL BE SCHEDULE 80 PVC UNDER ROAD AND DRIVEWAY SURFACES.	Y

ACCESSIBLE PARKING STALL PAVEMENT MARKING

NOT TO SCALE

2. ALL UTILITY INSTALLATION REQUIREMENTS, SEPARATIONS, AND CONDUIT SIZES TO BE VERIFIED WITH EACH UTILITY COMPANY PRIOR TO INSTALLATION OF ANY UNDERGROUND UTILITY CONDUIT. 3. SEE SITE ELECTRICAL PLANS FOR SPECIFIC SERVICE PROVIDER DETAILS.

BURIED CONDUIT DETAIL

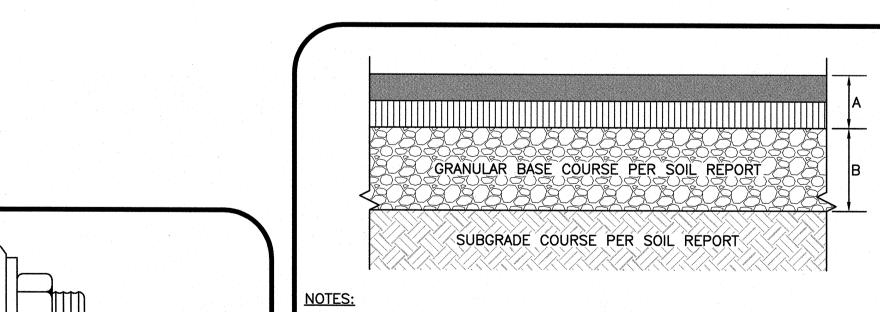


- COMPACT SOIL SUBGRADE UNIFORMLY TO AT LEAST 95 PERCENT OF ASTM
- PROOF-ROLL PREPARED SUBGRADE TO IDENTIFY SIFT POCKETS AND AREAS OF EXCESS YIELDING. EXCAVATE SOFT SPOTS. UNSATISFACTORY SOILS, AND AREAS OF EXCESSIVE PUMPING OR RUTTING, AND REPLACE
- . CONTRACTOR SHALL COORDINATE SURFACE, BINDER, BASE, AND SUBBASE COURSES WITH GEOTECHNICAL OR SOILS REPORT. IF AVAILABEL. REFER TO REPORT FOR RECOMMENDATIONS FOR LOCAL SOILS OR DRAINAGE
- BASE COURSE SHALL EXTEND 6 INCHES BEYOND PAVEMENT EDGE WHERE
- 5. PAVEMENT EDGES SHALL BE TAMPED WHERE PAVEMENT DOES NOT ABUT


STANDARD DUTY PAVING


- 1.5" ASPHALT CONCRETE BINDER COURSE (M3.11.03, TABLE A, BINDER
- B = 12" GRANULAR BASE COURSE M1.03.1, PROCESSED GRAVEL FOR

STANDARD DUTY BITUMINOUS PAVEMENT

	NOTES	CONCRETE 2'-0"		
MOUNTING DESCRIPTION RETRO-FLECTIVE	NOTES: 1. ALL WATER MAIN FITTINGS, BENDS, TEES,	THRUST BLOCK THRUST THRUST BLOCK THRUST BLOCK		18'
7' - 0" WHITE ON YES	PLUGS ETC. SHALL BE RESTRAINED W/ THRUST BLOCKS EXCEPT WHERE NOTED. 2. ALL THRUST BLOCKS	BEND ANGLE		FINISHE
7' - 0" RED ON YES WHITE	& COLLARS SHALL BE INSTALLED SO THAT THEY BEAR AGAINST UNDISTURBED EARTH. 3. SIZE OF CONCRETE THRUST BLOCKS SHALL	VARIES BACK FILL CONCRETE THRUST BLOCK FLAG ROCK PLUG THRUST BLOCK		CO CO
7' - 0" GREEN & YES WHITE	BE AS NOTED BELOW. 4. MINIMUM COMPRESSIVE STRENGTH OF THRUST			SEI SIZ
	BLOCK CONCRETE SHALL BE 3,000 P.S.I.	WATER MAIN WATER BACK FILL	1-60.	

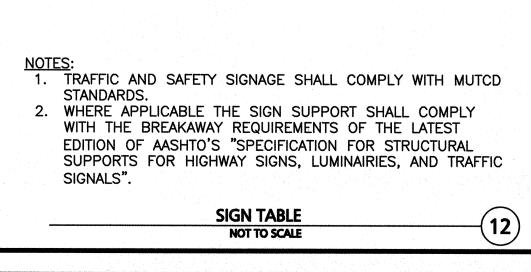


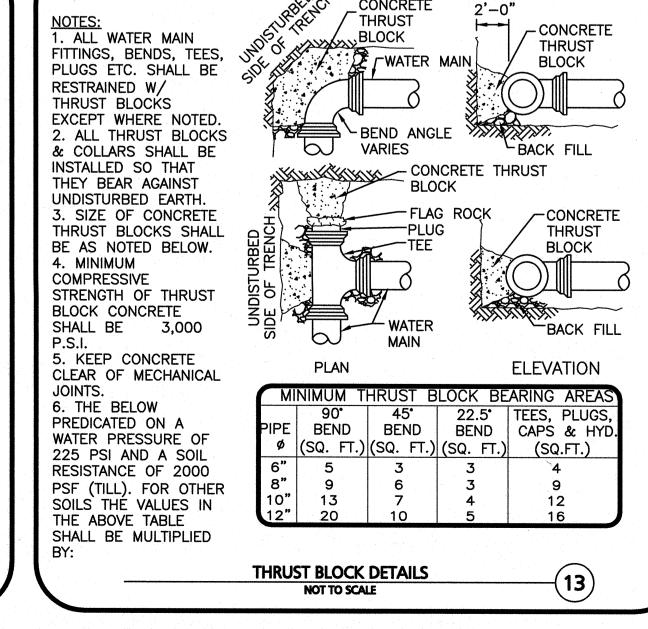

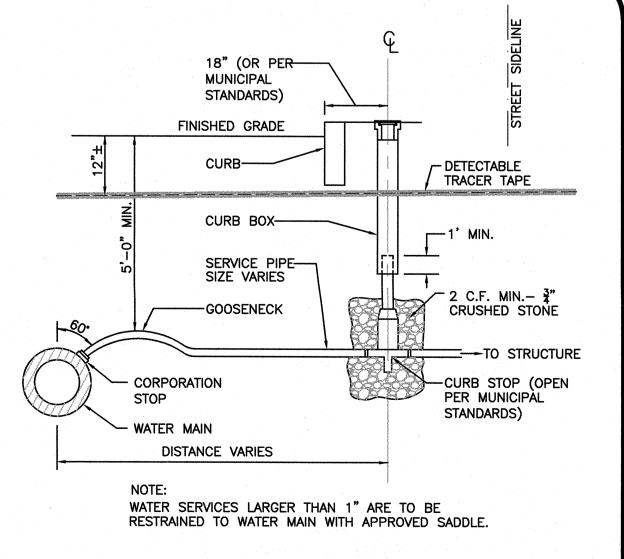

TYPICAL WATER SERVICE CONNECTION

NOT TO SCALE

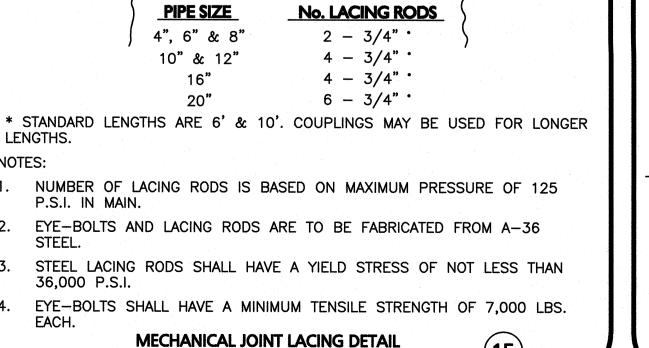

NOT TO SCALE


_EYE BOLT


2 NUTS PER BOLT

MECHANICAL JOINT

GATE OR FITTING

LACING RODS

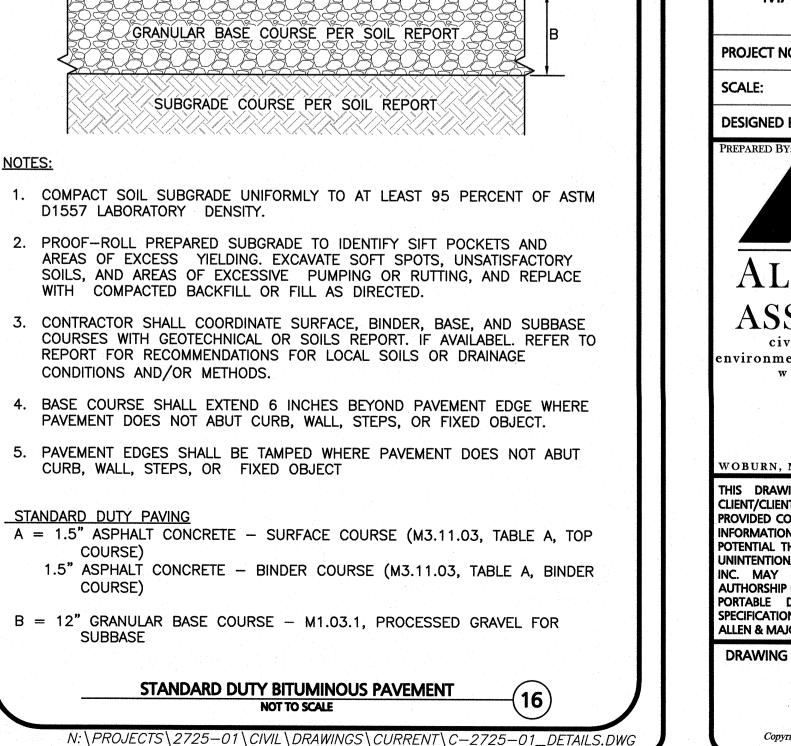

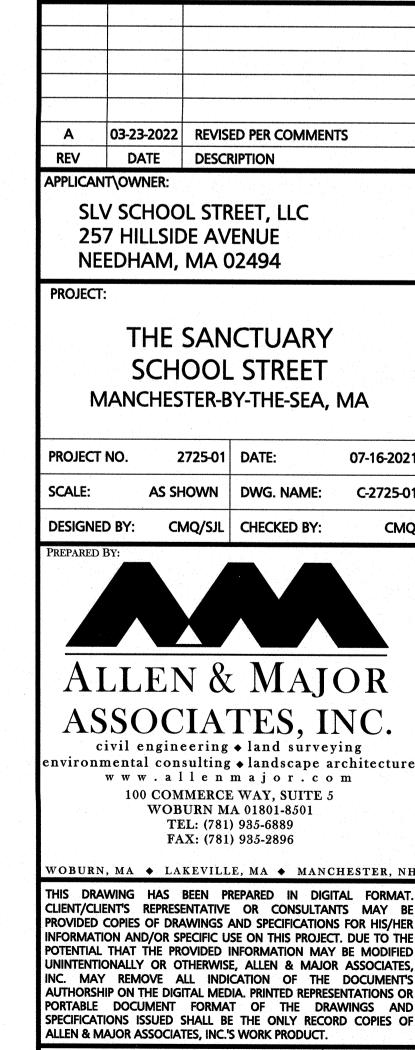


PROFESSIONAL ENGINEER FOR

ALLEN & MAJOR ASSOCIATES, INC.


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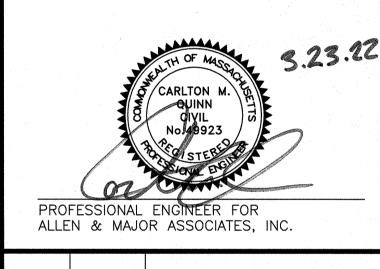
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07-16-2021



C-502

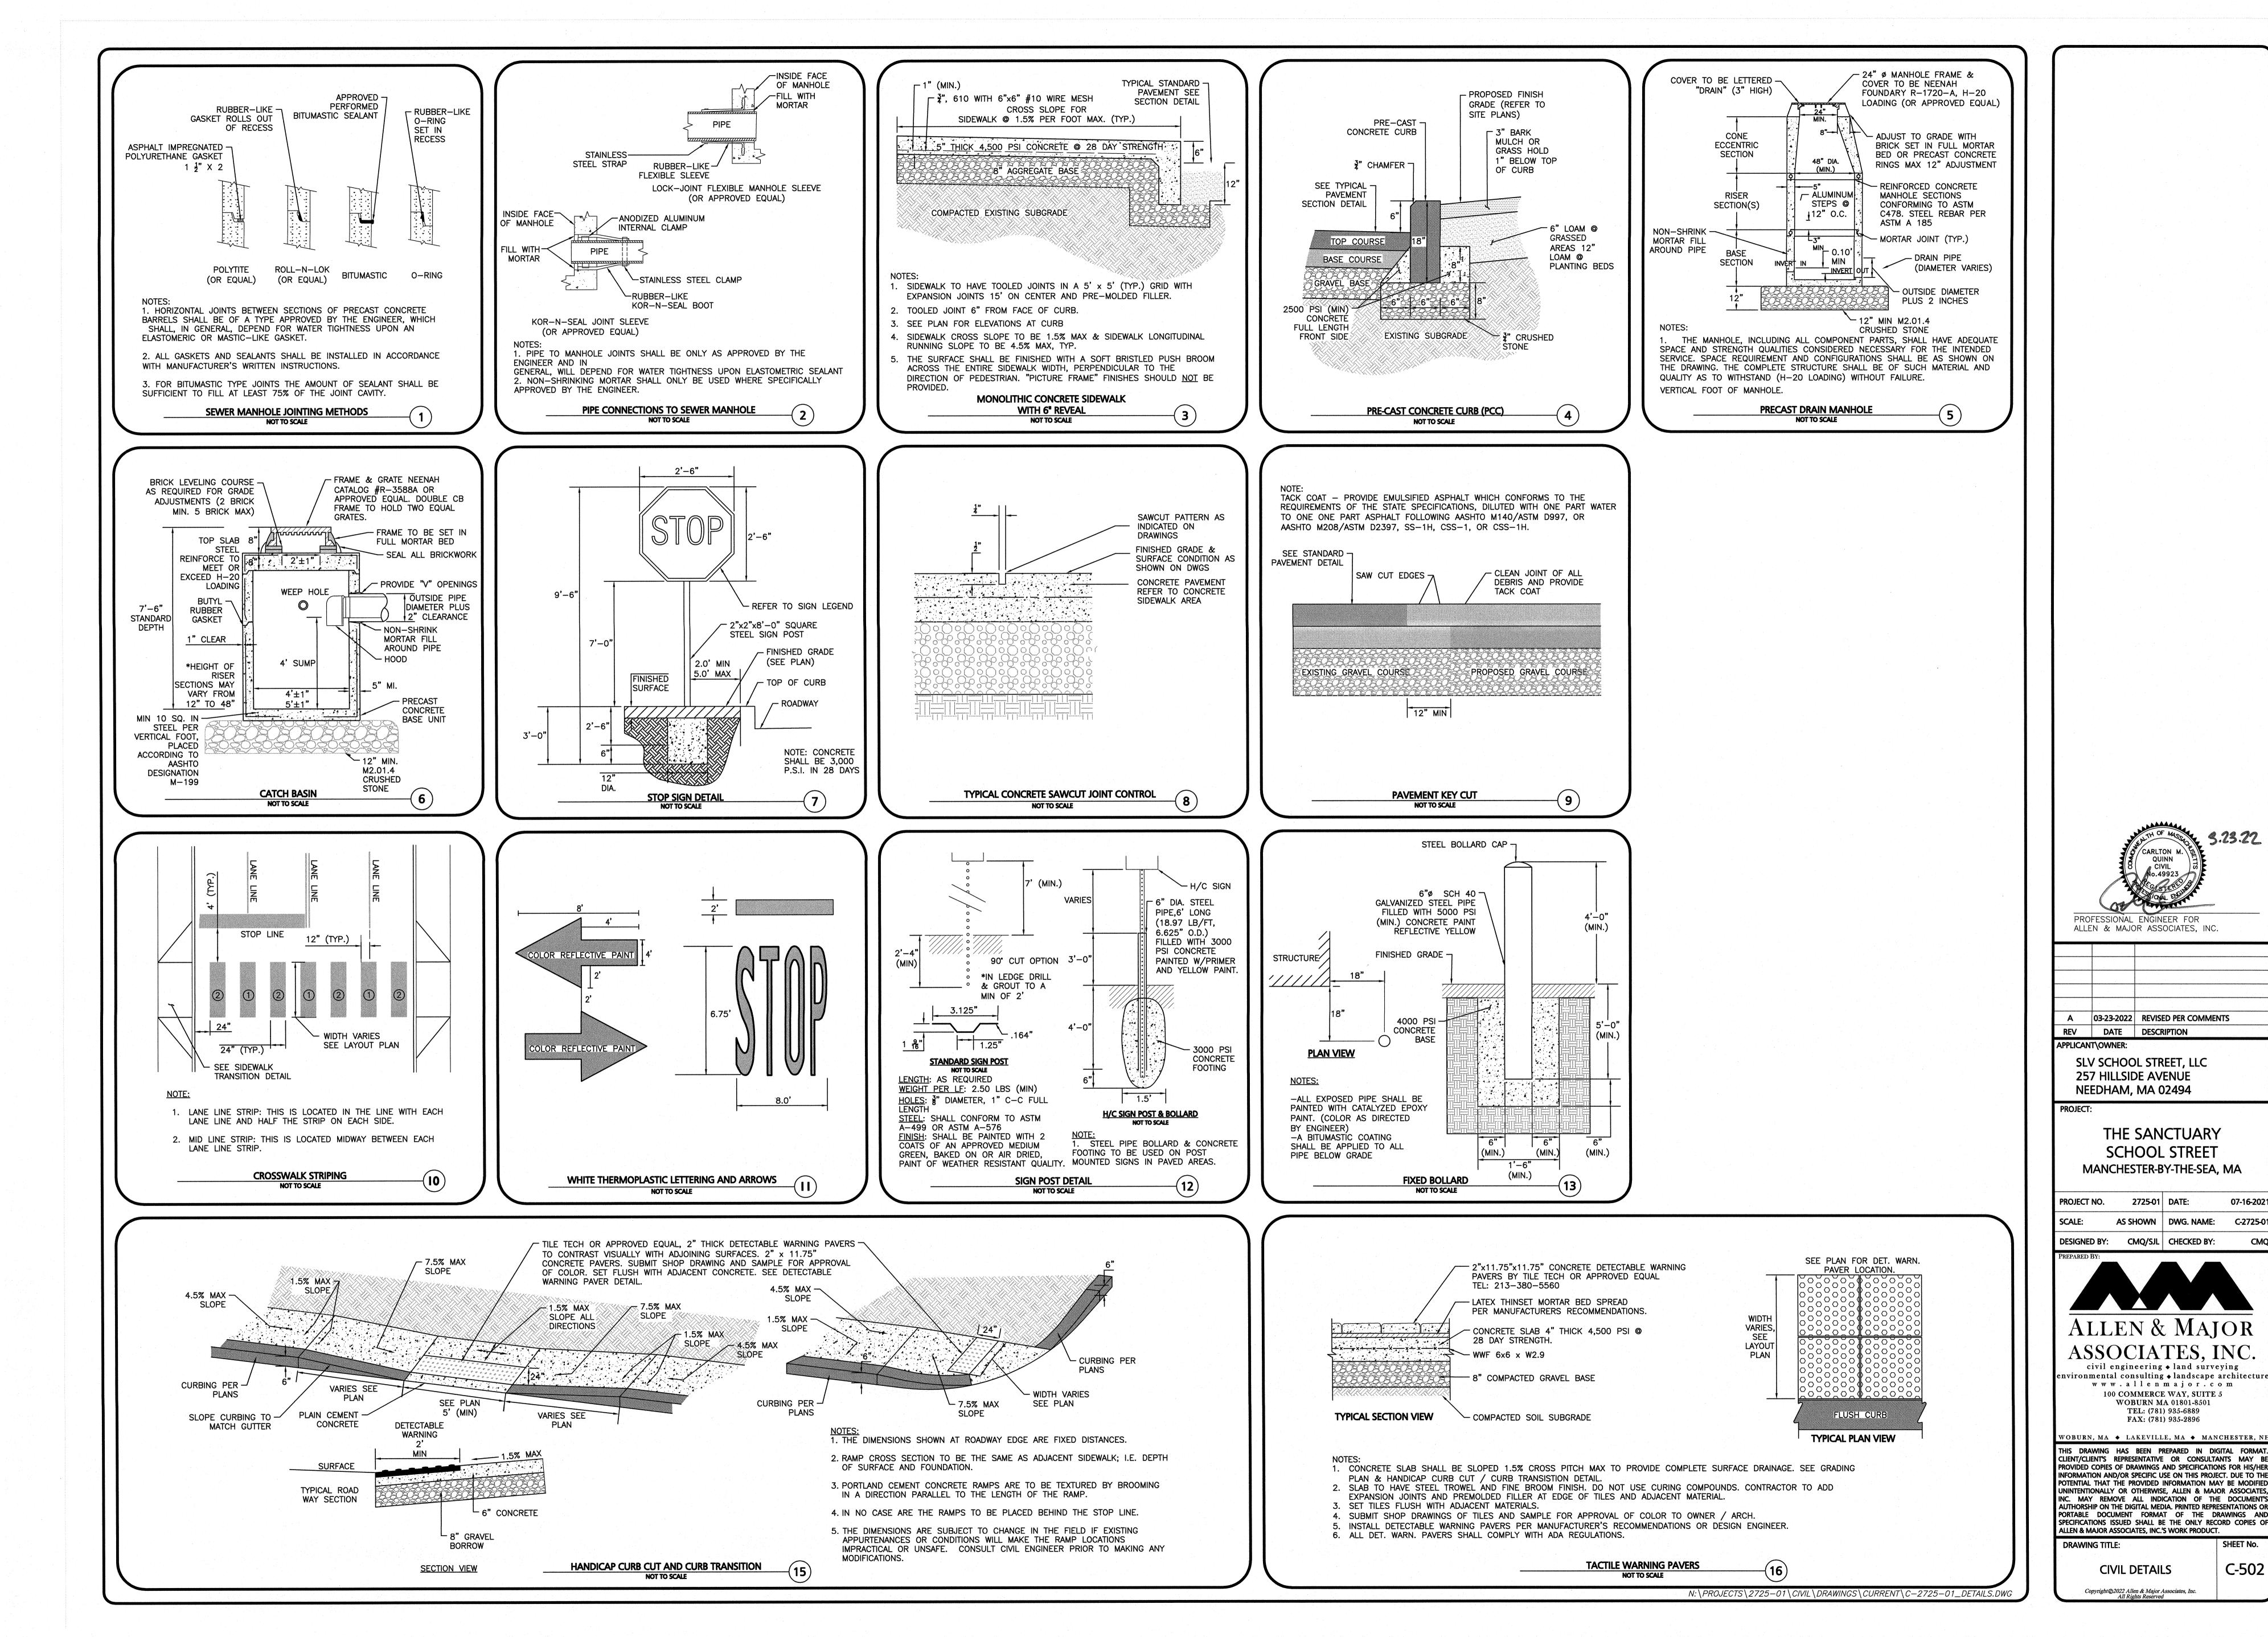

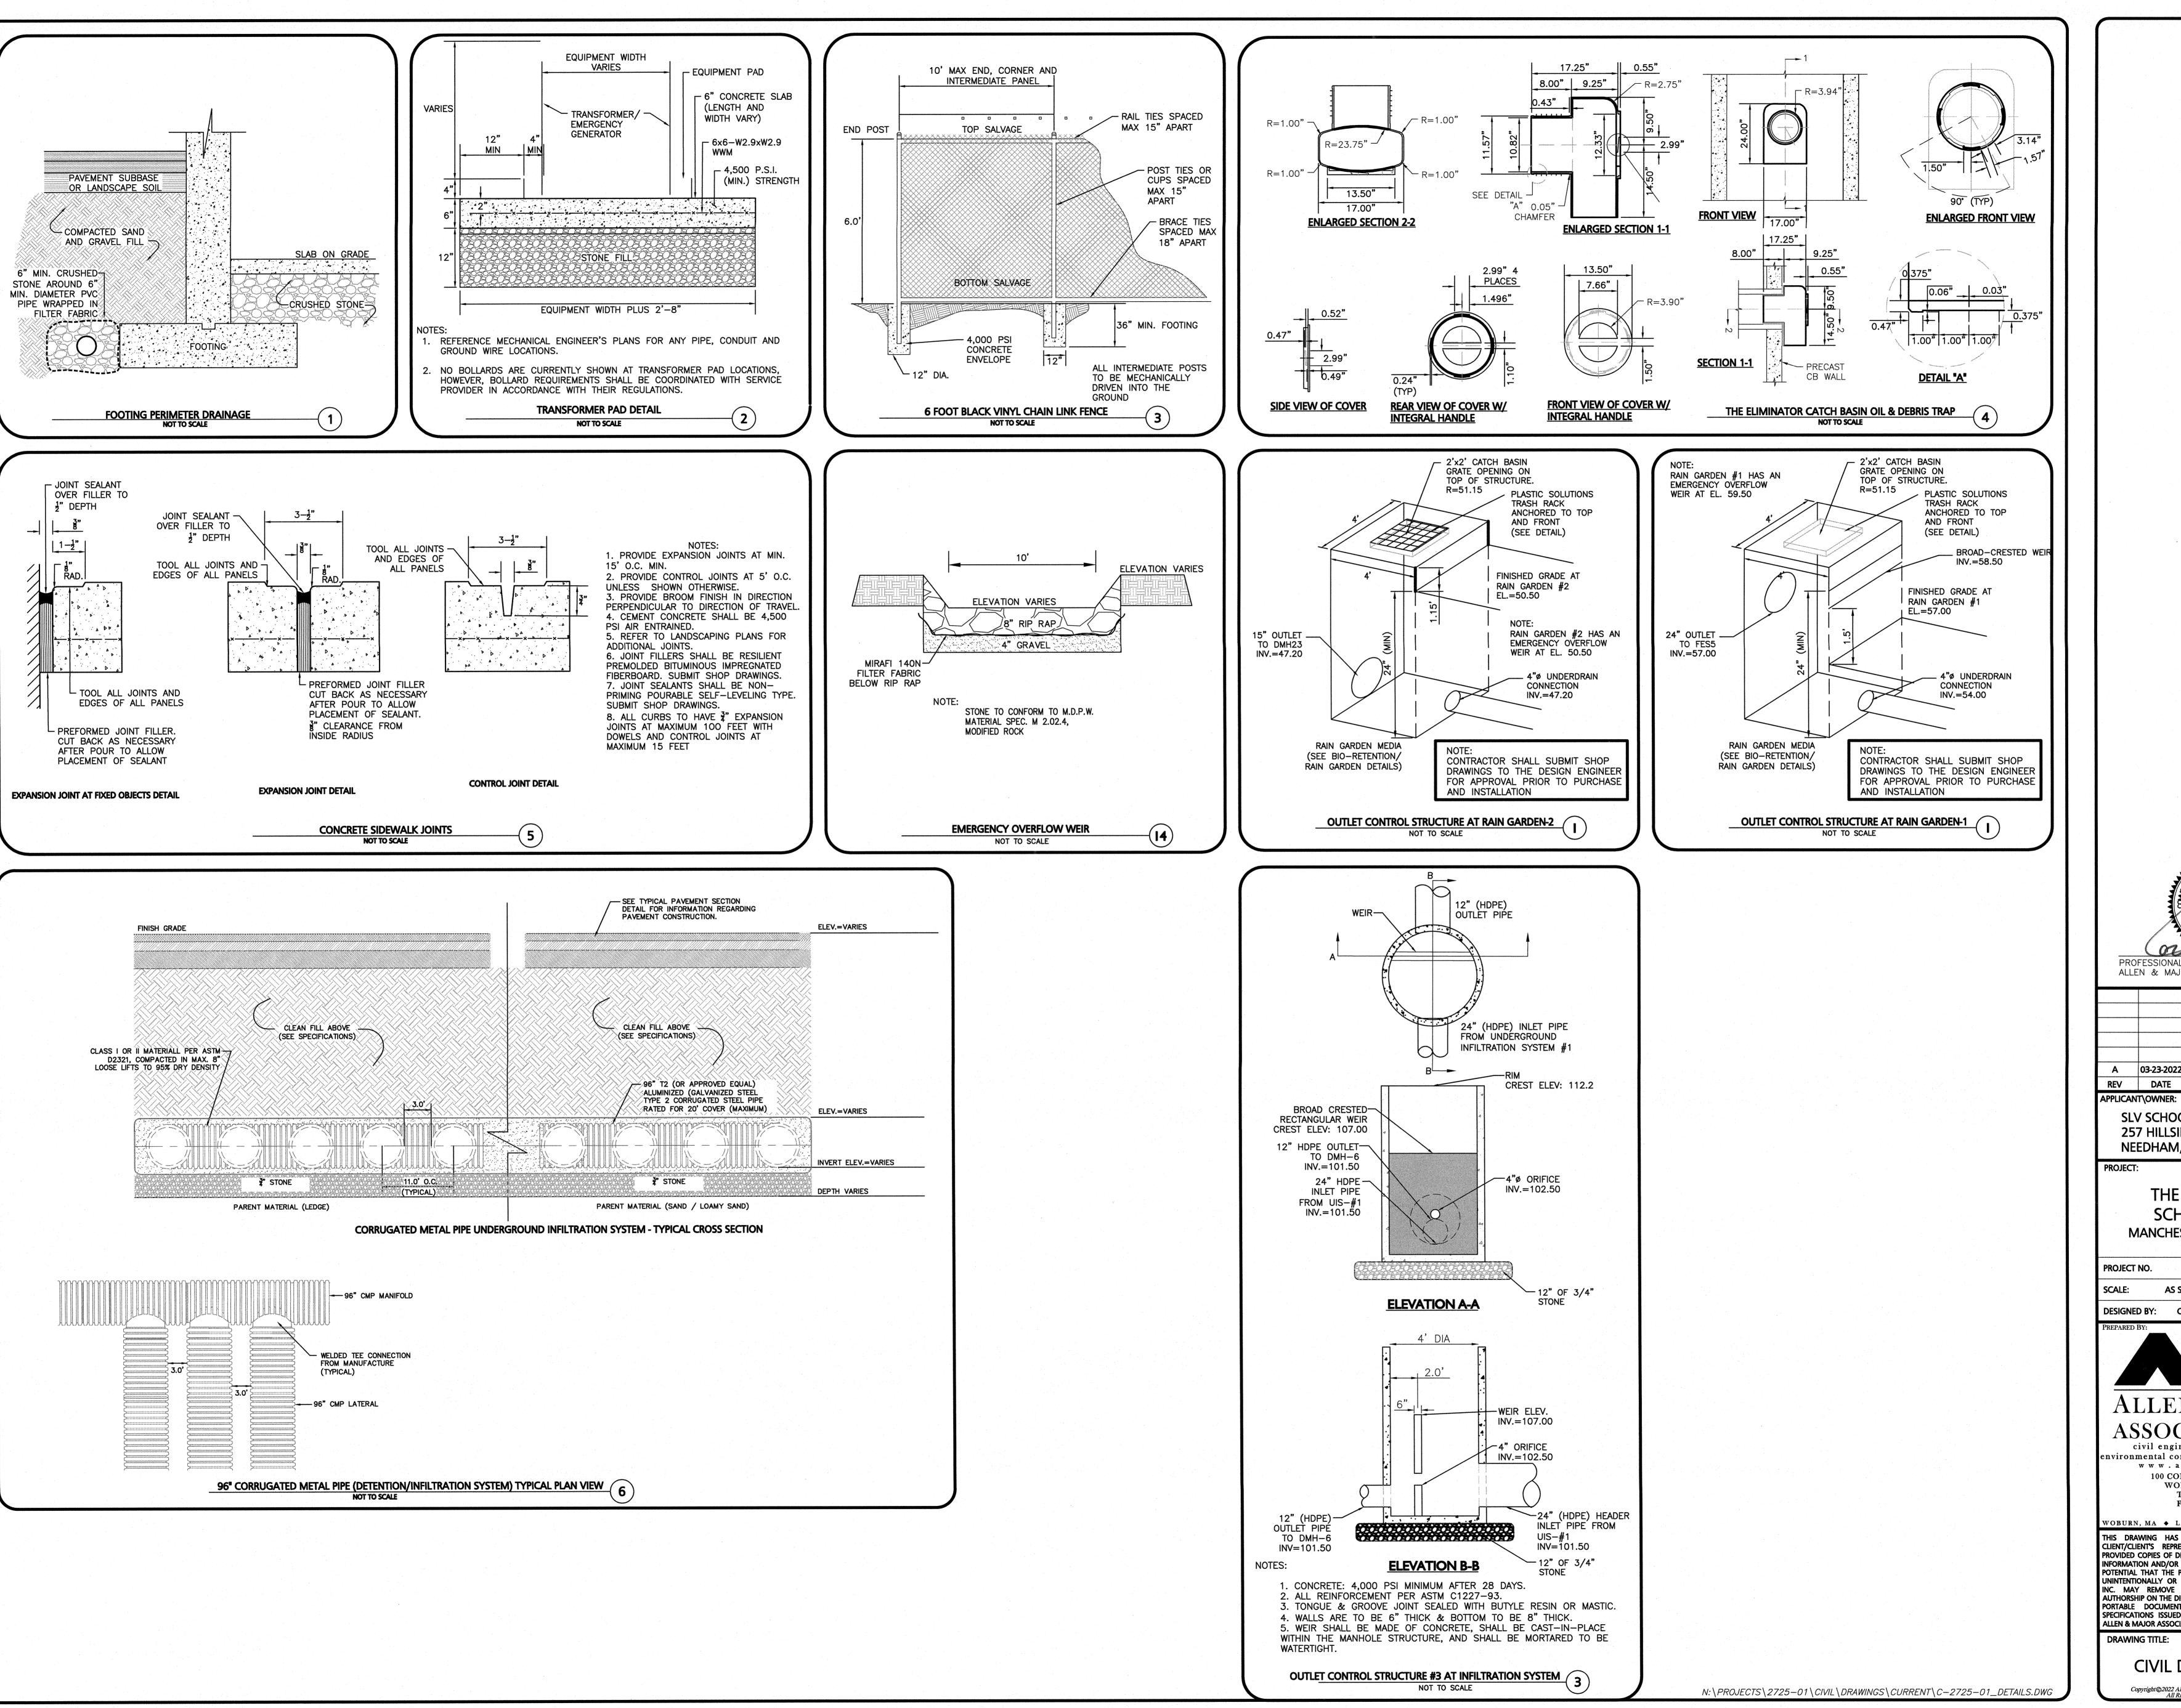

A 03-23-2022 REVISED PER COMMENTS REV DATE DESCRIPTION

SLV SCHOOL STREET, LLC 257 HILLSIDE AVENUE NEEDHAM, MA 02494

PROJECT:

THE SANCTUARY SCHOOL STREET MANCHESTER-BY-THE-SEA, MA

PROJECT NO. 2725-01 DATE: 07-16-2021 SCALE: AS SHOWN DWG. NAME: C-2725-0 DESIGNED BY: CMQ/SJL CHECKED BY:



ASSOCIATES, INC. civil engineering ◆ land surveying

environmental consulting + landscape architecture www.allenmajor.com 100 COMMERCE WAY, SUITE 5 **WOBURN MA 01801-8501** TEL: (781) 935-6889


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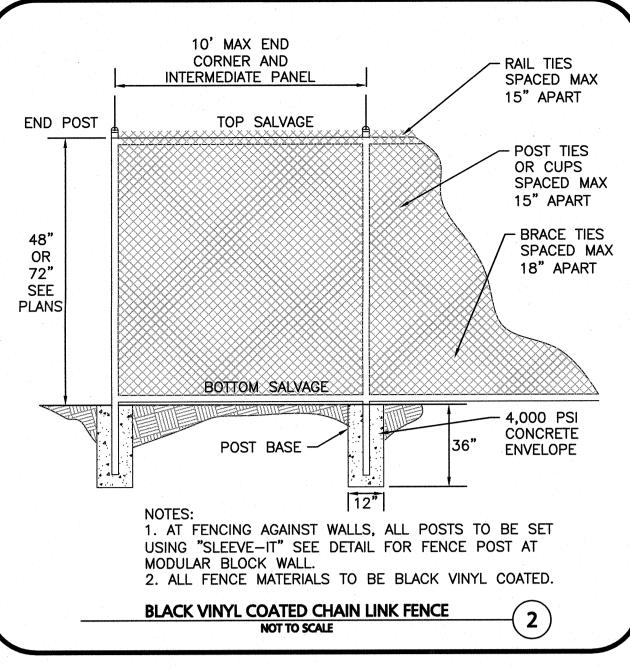
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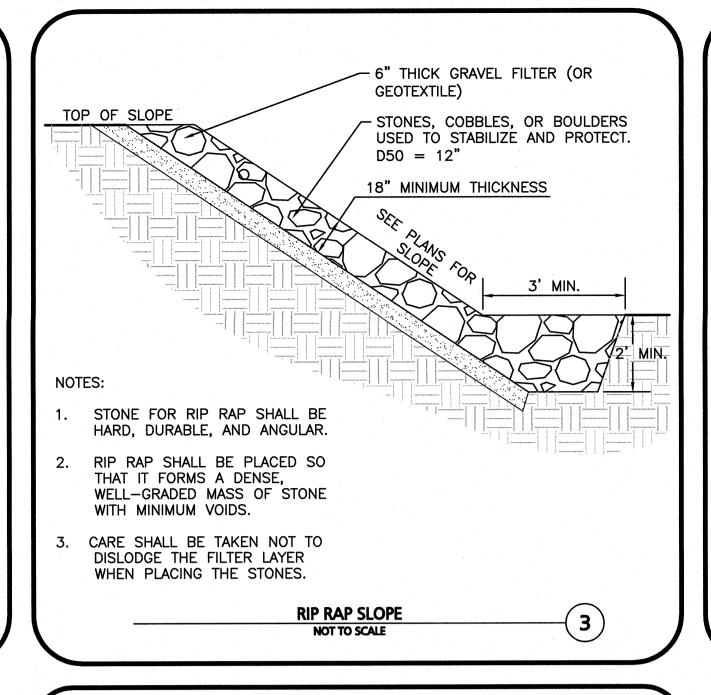
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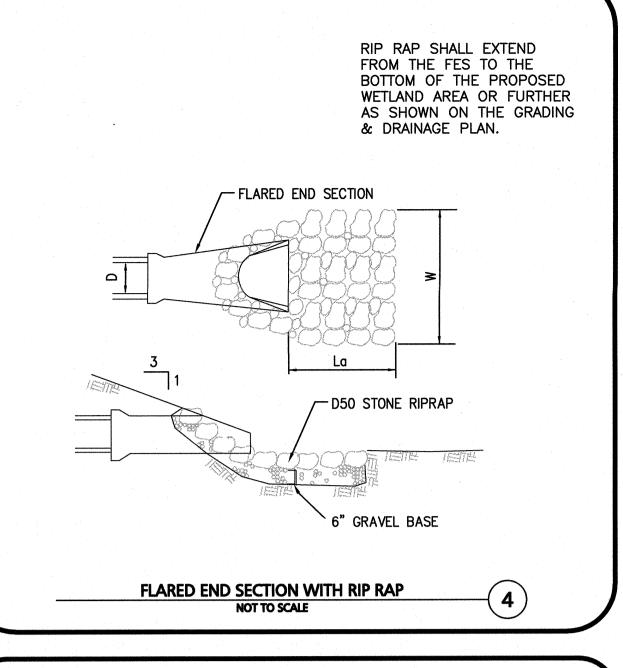
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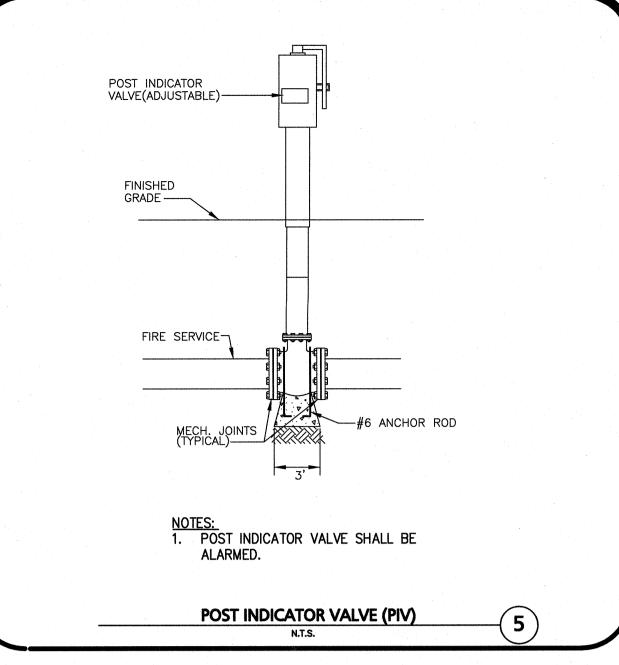
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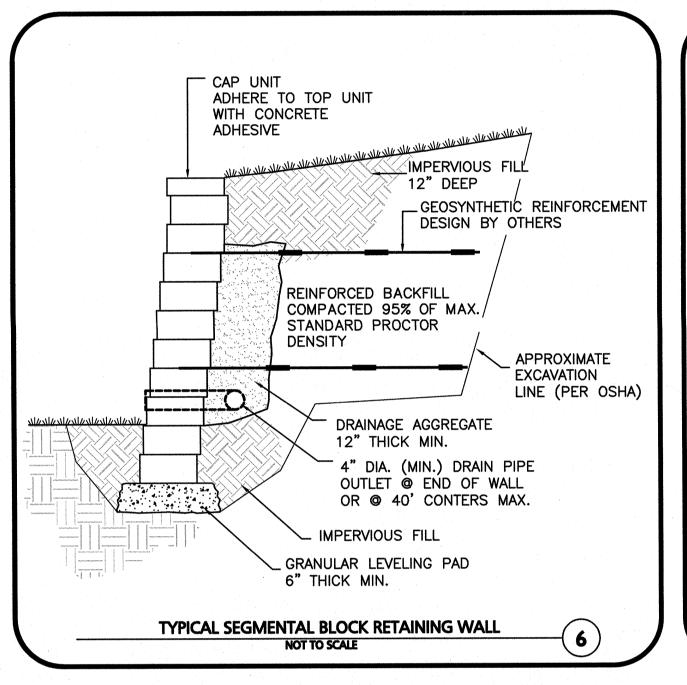













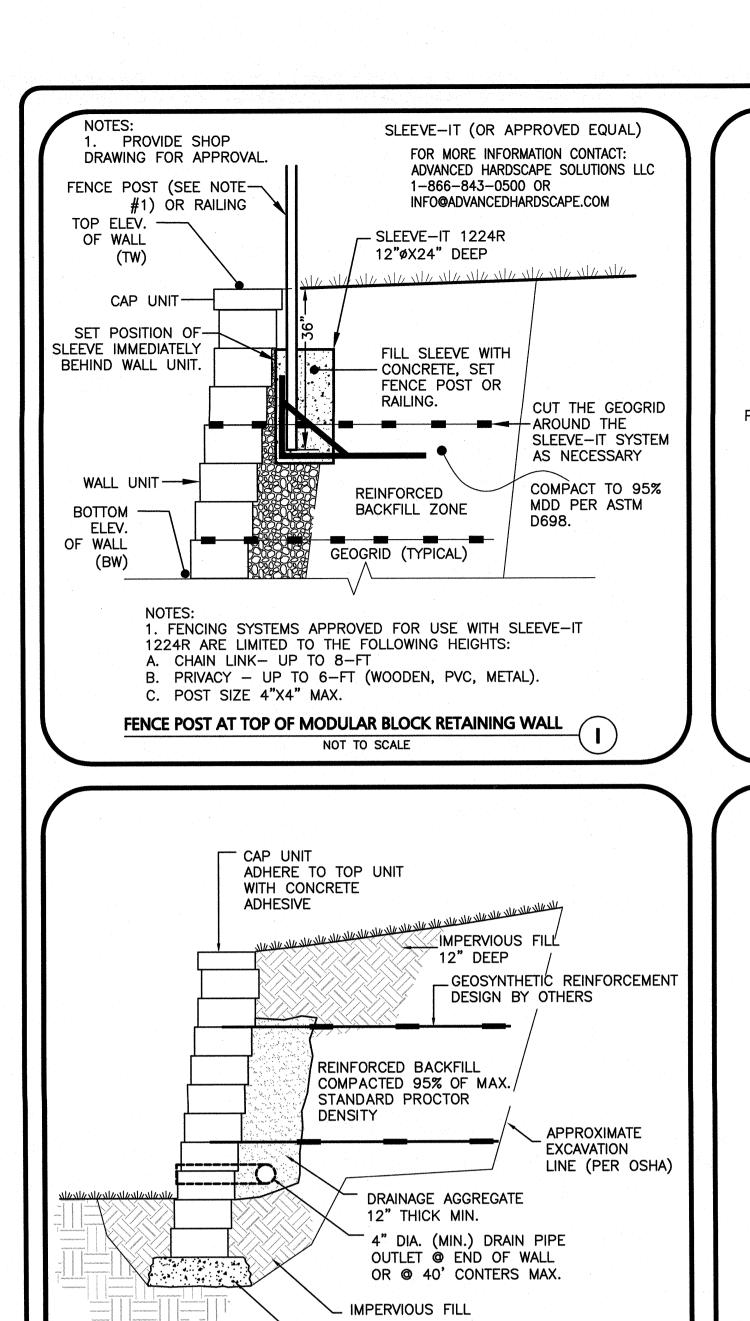


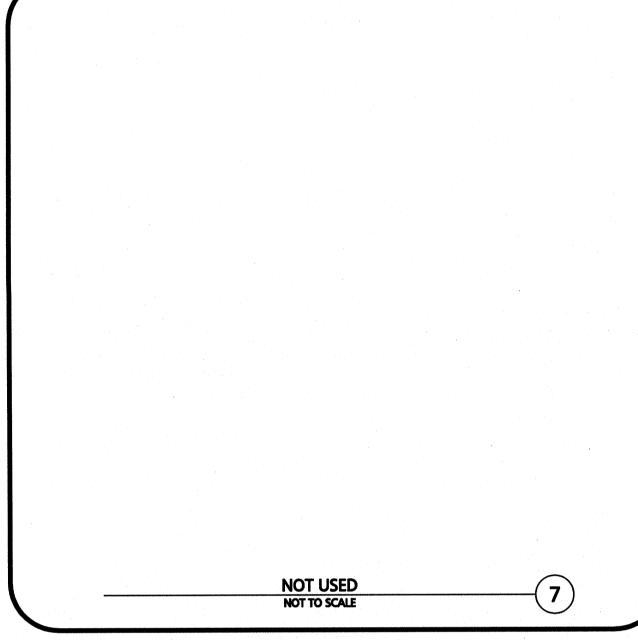

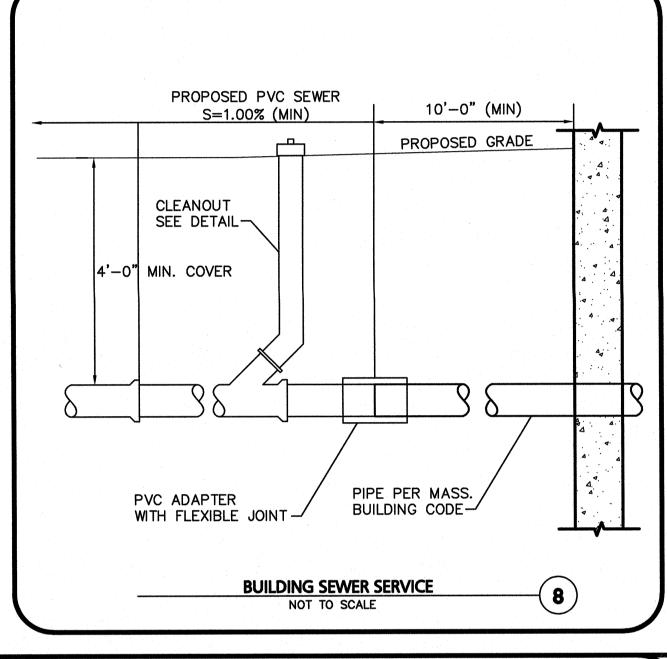


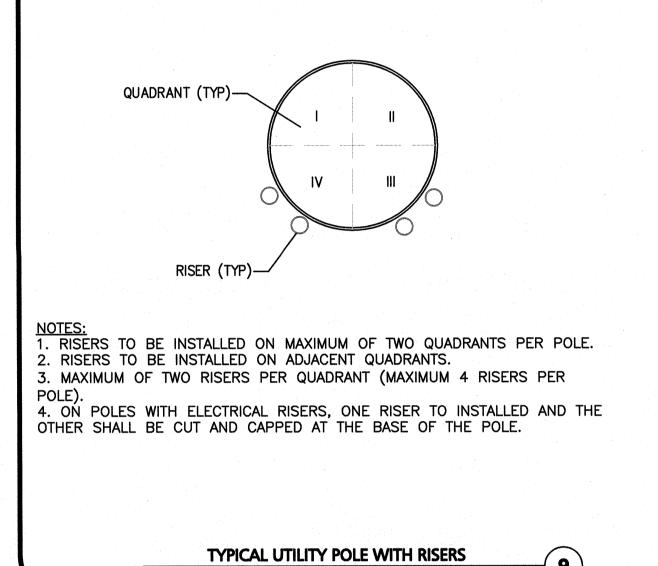

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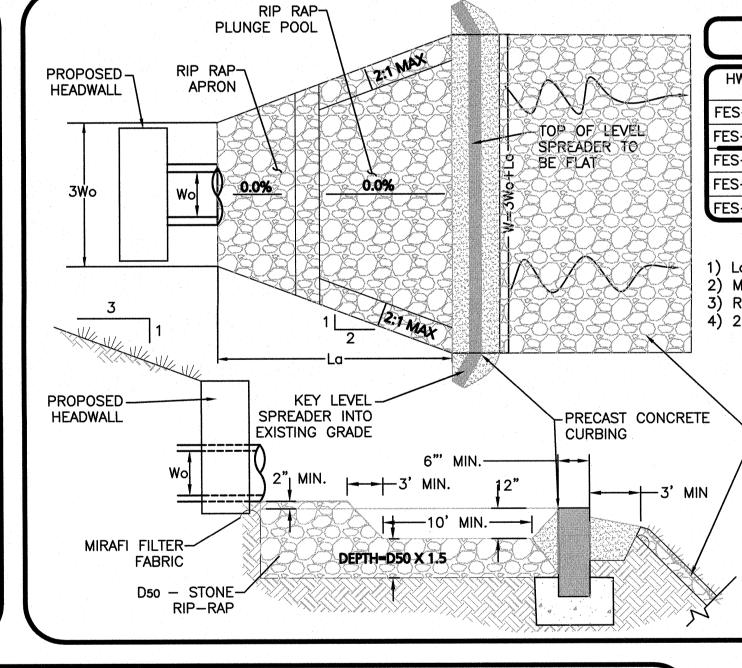
PRECAST CONCRETE SEWER MANHOLE

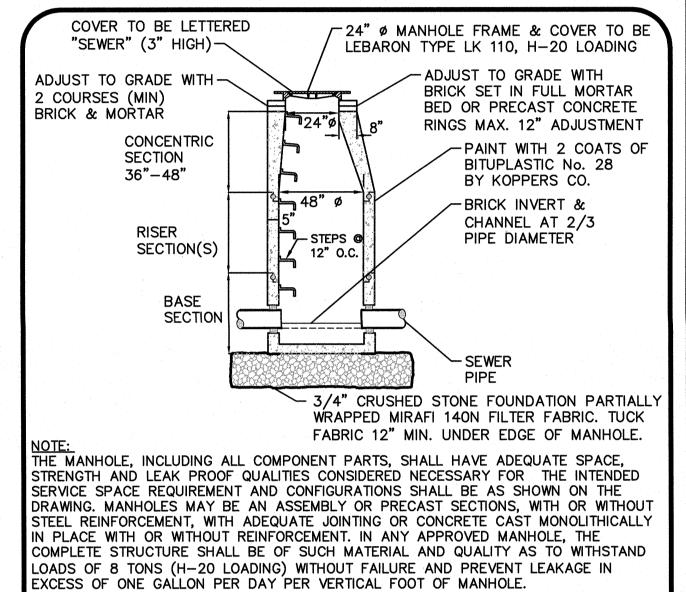

LEAST 18 INCHES. 2. THE PIPE CROSSING SHALL OCCUR AS CLOSE TO 90° AS PRACTICABLE. . THE PIPE JOINTS SHALL BE STAGGERED TO PROVIDE THE MAXIMUM SEPARATION FROM THE POINT OF CROSSING. 4. THE CROSSING SHALL BE ENCASED IN CONCRETE FOR THE ENTIRE WIDTH OF THE TRENCH AND FOR A DISTANCE OF 8 LINEAR FEET CENTERED ON THE CROSSING.

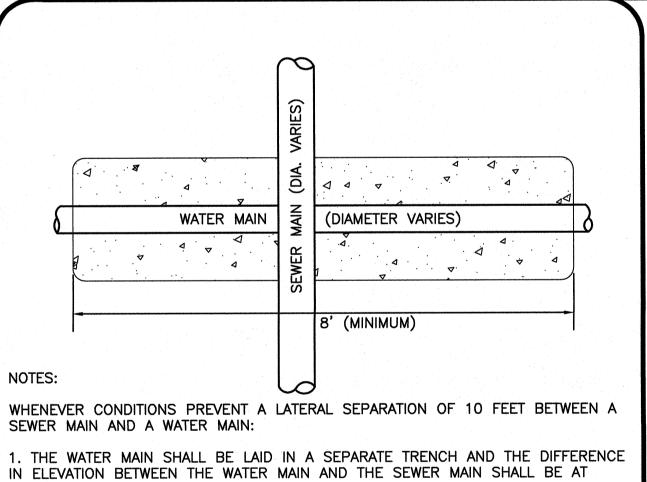
SEWER / WATER CROSSING DETAIL


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	HW	Q25(cfs)	Wo=Do	*La (1)	W		RIP RAP DEPTH (3)	POOL DEPTH (4)	
	FES-1	2.98	1.00'	12.4'	15.4'	0.50	0.75	14"	
	FES-2	1.12	1.00'	9.0'	12.0'	0.50	0.75	14"	
	FES-3	2.25	1.00'	11.1'	14.1'	0.50	0.75'	14"	
	FES-4	0.63	1.00'	8.1'	11.1'	0.50	0.75	14"	
	FES-5	7.35	2.00'	18.7'	24.7'	0.50	0.75	14"	
1) La=(1.7Q/Do^1.5) + 8Do (NO TAILWATER) 2) MIN. DIAMETER=6"=0.50' 3) RIP-RAP DEPTH = 1.5 x D50 = 1.5 x 0.50 = 0.75 4) 2" BELOW PIPE + 12" DEPTH (SEE BELOW) NOTE:									
	1. FIFTY PERCENT (50%) BY WEIGHT OF THE RIPRAP MIXTURE SHALL BE SMALLER THAN THE MEDIAN SIZE STONE DESIGNATED AS D50. THE LARGEST STONE SIZE IN THE MIXTURE SHALL BE 1.5 TIMES THE D50 SIZE. THE RIPRAP SHALL BE REASONABLY WELL GRADED. 3' MIN MINIMUM 6" RIP-RAP. TOP OF RIP-RAP SHALL BE FLUSH WITH								
		EXISTING G	<u></u>	L		ADER DETA	AIL		

OUTLET PROTECTION SUMMARY






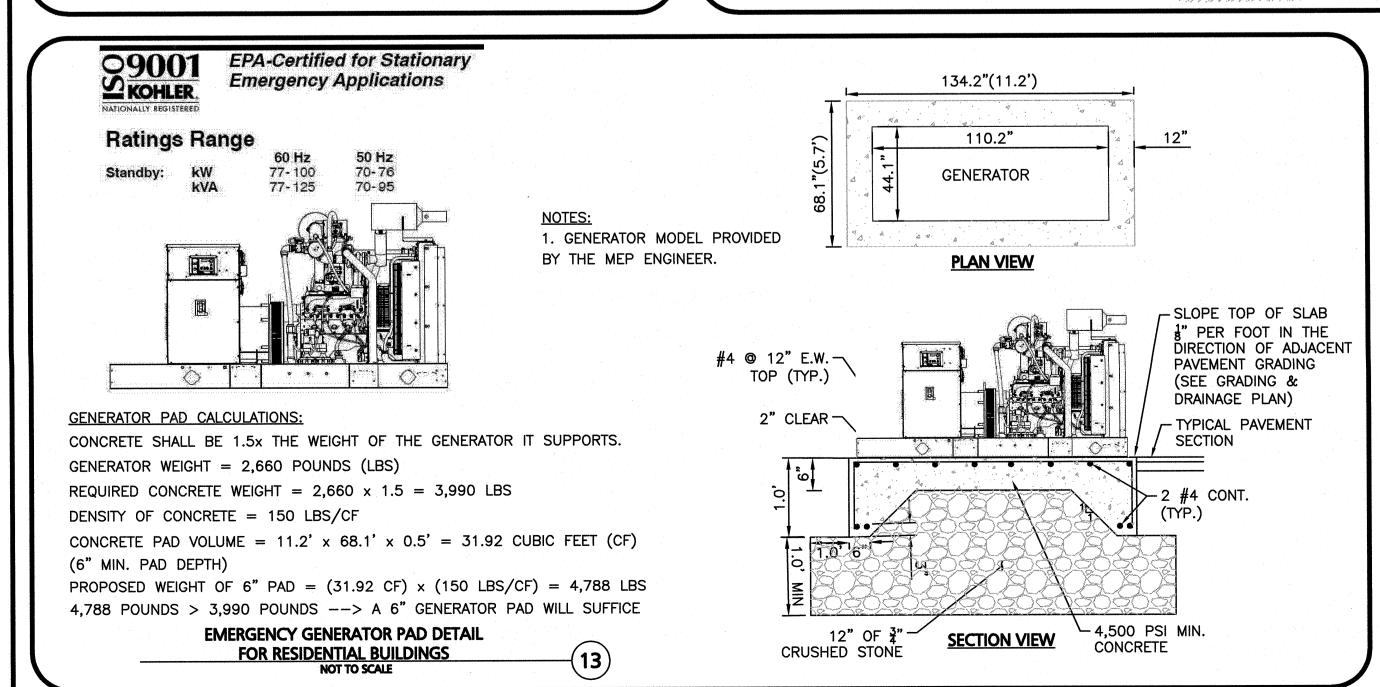


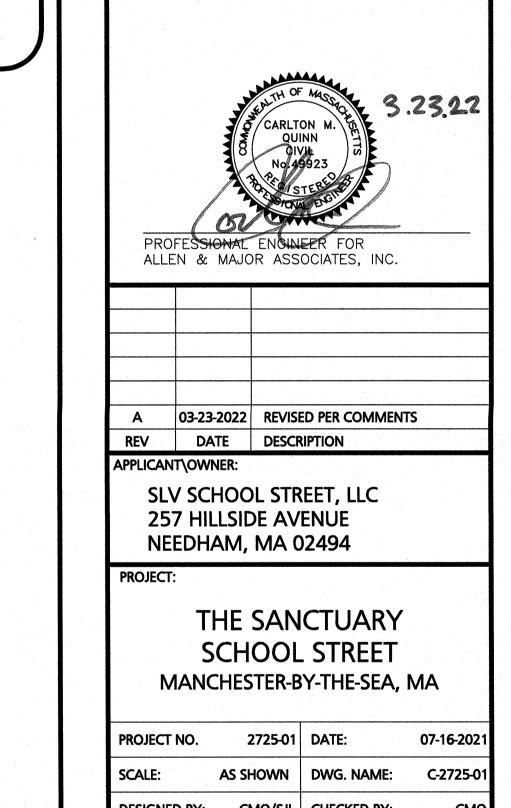CIVIL DETAILS

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C-504



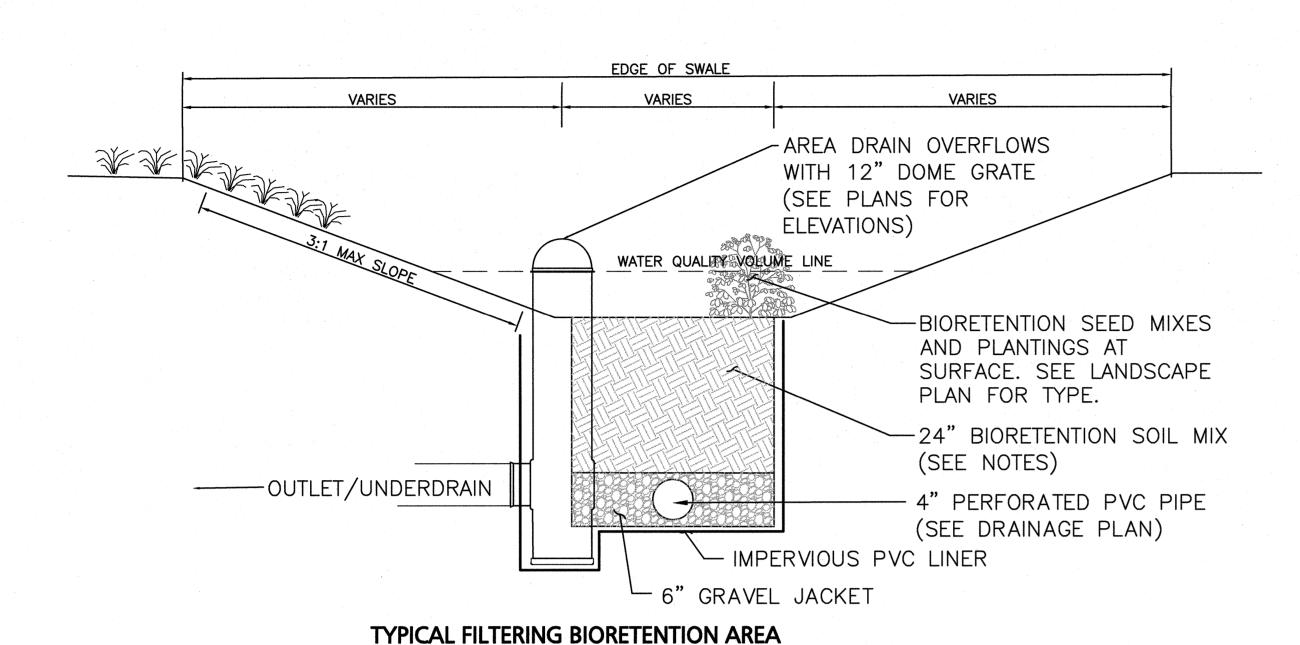

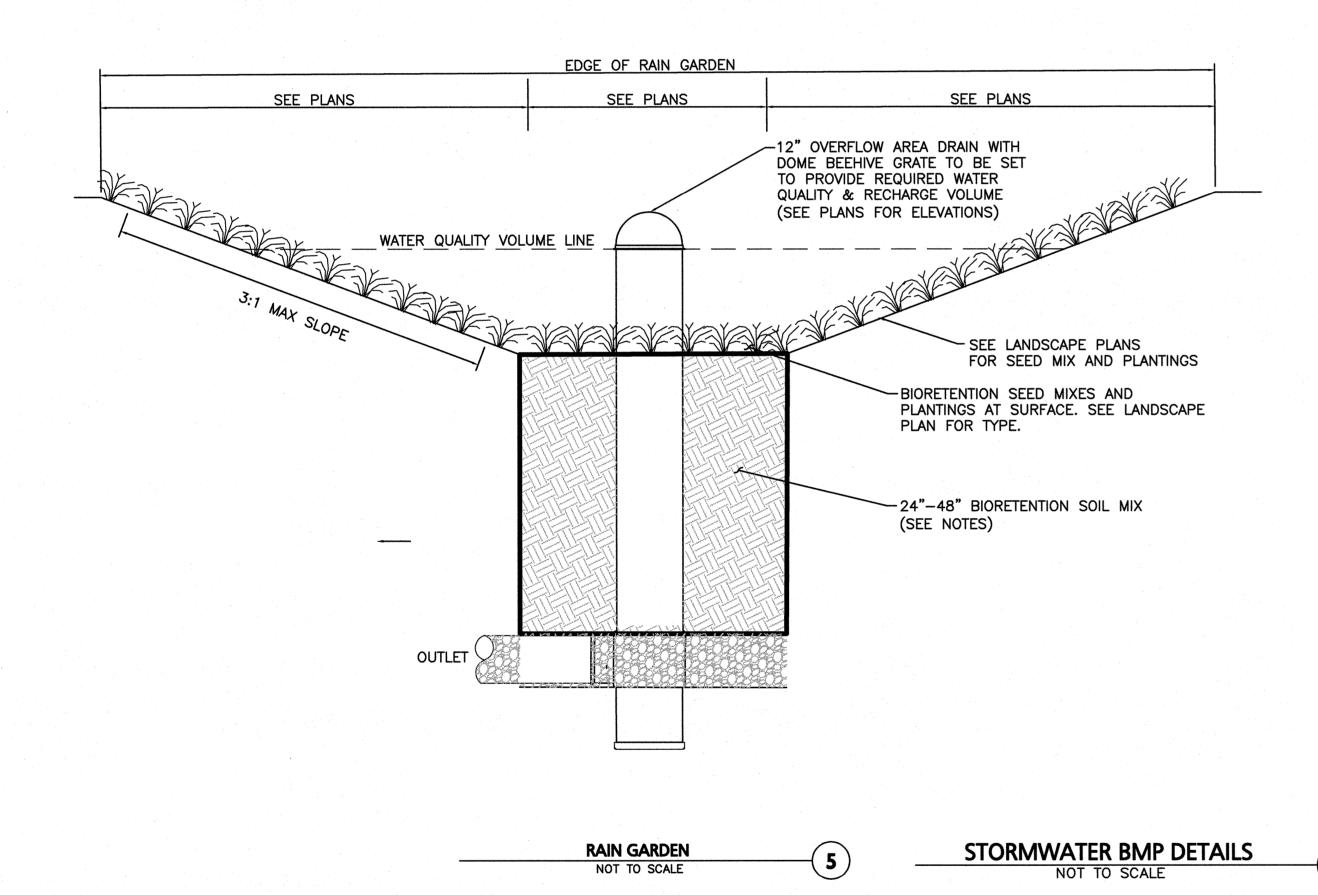BIORETENTION AREA NOTES:

- BIORETENTION SOIL MIX REQUIREMENTS:

 1. THE SOIL MIX FOR BIORETENTION AREAS SHALL BE FROM OFFSITE SOURCES AND SHOULD BE A MIXTURE OF SAND COMPOST AND SOIL. DO NOT REUSE EXISTING TOPSOILS. SOIL SHALL CONTAIN:

 40-50% SAND
 - 20-30% TOPSOIL
 25-30% COMPOST (AGED LEAF MULCH AND ORGANIC MATTER AS AVAILABLE FROM NEWLAND FARMS, 145 NEWLAND STREET NORTON, MA 508-285-3169).
 5% CLAY (MAX.)
- 2. THE SOIL MIX MUST BE UNIFORM, FREE OF STONES, STUMPS, ROOTS OR SIMILAR OBJECTS LARGER THAN 1/2
- 3. SOIL pH SHOULD GENERALLY BE BETWEEN 5.5-6.5, A RANGE THAT IS OPTIMAL FOR MICROBIAL ACTIVITY AND ADSORPTION OF NITROGEN, PHOSPHORUS, AND OTHER POLLUTANTS.
- 4. USE SOIL WITH 7% TO 10% ORGANIC CONTENT OF TOTAL DRY WEIGHT.
- 5. THE TOPSOIL COMPONENT SHALL BE A SANDY LOAM, LOAMY SAND OR LOAM TEXTURE, PER USDA TEXTURE TRIANGLE. SOILS SHALL BE COMPOSED OF A NATURAL, FERTILE, FRIABLE SOILS. THE SOILS SHALL BE SUITABLE FOR THE GERMINATION OF SEEDS AND SUPPORT OF VEGETATIVE GROWTH AND MATCH THE PARTICLE DISTRIBUTION AND ORGANIC CONTENT REQUIREMENTS BELOW. TOPSOIL SHALL BE FREE OF ANY OBJECTS GREATER THAN ½" INCH IN DIAMETER INCLUDING STONES, EARTH CLODS, OR STICKS. IT SHALL CONTAIN NO STUMPS, CLAY LUMPS, ROOTS, OTHER OBJECTIONABLE, EXTRANEOUS MATTER OR DEBRIS NOR SHALL CONTAIN
- 6. THE COMPOST SHALL NOT CONTAIN BIOSOLIDS. THE COMPOST MUST BE PROCESSED FROM YARD WASTE IN ACCORDANCE WITH MASSDEP GUIDELINES.
- 7. THE SAND COMPONENT SHOULD BE GRAVELLY SAND THAT MEETS ASTM D 422.


 SIEVE SIZE PERCENT PASSING


2-INCH 100 34-INCH 70-100 44-INCH 50-80 U.S. NO. 40 15-40 U.S. NO. 200 0-3

8. A SIEVE ANALYSIS, PH, AND ORGANIC MATTER TEST SHALL BE SENT TO UMASS SOIL TESTING LABORATORY OR APPROVED EQUAL, TO MEET ABOVE REQUIREMENTS FOR SOIL MIX. TEST RESULTS TO BE SENT TO LANDSCAPE ARCHITECT FOR APPROVAL PRIOR TO PLACEMENT. SOIL SHALL BE ADJUSTED TO MEET THE SPECIFICATIONS THROUGH THE ADDITION OF SAND, COMPOST, LIMESTONE, OR ALUMINUM SULFATE TO BRING IT WITHIN THE SPECIFIED LIMITS AT NO ADDITIONAL COST TO THE OWNER.

GENERAL NOTES:

- THE CONTRACTOR IS SPECIFICALLY CAUTIONED THAT THE LOCATION AND/OR ELEVATION OF EXISTING UTILITIES AND STRUCTURES AS SHOWN ON THESE PLANS IS BASED ON RECORDS OF VARIOUS UTILITY COMPANIES AND WHERE POSSIBLE, MEASUREMENTS TAKEN IN THE FIELD. THE LOCATIONS OF EXISTING UNDERGROUND UTILITIES ARE SHOWN IN AN APPROXIMATE WAY ONLY AND HAVE NOT BEEN INDEPENDENTLY VERIFIED BY THE OWNER OR IT'S REPRESENTATIVE. THE CONTRACTOR SHALL DETERMINE THE EXACT LOCATION OF ALL EXISTING UTILITIES BEFORE COMMENCING WORK, AND AGREES TO BE FULLY RESPONSIBLE FOR ANY AND ALL DAMAGES WHICH MIGHT BE OCCASIONED BY THE CONTRACTOR'S FAILURE TO EXACTLY LOCATE AND PRESERVE ANY AND ALL UNDERGROUND UTILITIES. THIS INFORMATION IS NOT TO BE RELIED ON AS BEING EXACT OR COMPLETE. THE LOCATION OF ALL UNDERGROUND UTILITIES AND STRUCTURES SHALL BE VERIFIED IN THE FIELD BY THE CONTRACTOR PRIOR TO THE START OF CONSTRUCTION. THE CONTRACTOR MUST CONTACT THE APPROPRIATE UTILITY COMPANY, ANY GOVERNING PERMITTING AUTHORITY, AND "DIGSAFE" AT LEAST 72 HOURS PRIOR TO ANY EXCAVATION WORK TO REQUEST EXACT FIELD LOCATION OF UTILITIES AND THE ENGINEER SHALL BE NOTIFIED IN WRITING OF ANY UTILITIES INTERFERING WITH THE PROPOSED CONSTRUCTION AND APPROPRIATE REMEDIAL ACTION TAKEN BEFORE PROCEEDING WITH THE WORK. IT SHALL BE THE RESPONSIBILITY OF THE CONTRACTOR TO RELOCATE ALL EXISTING UTILITIES WHICH CONFLICT WITH THE PROPOSED IMPROVEMENTS SHOWN ON THE PLANS.
- 2. THE INFORMATION SHOWN ON THIS PLAN IS THE SOLE PROPERTY OF ALLEN & MAJOR ASSOCIATES, INC. IT'S INTENDED USE IS TO PROVIDE INFORMATION. ANY ALTERATION, MISUSE, OR RECALCULATION OF INFORMATION OR DATA WITHOUT THE EXPRESSED, WRITTEN CONSENT OF ALLEN & MAJOR ASSOCIATES, INC. IS STRICTLY
- 3. SEE NOTES AND ABBREVIATIONS PLAN; SHEET ABB-1 FOR ADDITIONAL NOTES
- 4. ALL EROSION CONTROL MEASURES AS SHOWN AND EROSION CONTROL PLANS SHALL BE IN PLACE PRIOR TO ANY RE-GRADING, DEMOLITION, OR PLANTING ACTIVITY.
- 5. EXCAVATION, FILLING AND PLANTING SHALL OCCUR IN THE DRY. WATER LEVELS MAY BE LOWERED IN THE REPLICATION AREA BY RELYING ON DRY SEASON AND OR DRY SPELLS; OR MAY BE ACCOMPLISHED THROUGH THE USE OF DEWATERING METHODS.
- 6. WATER FROM ANY DEWATERING OPERATION SHALL BE TREATED TO REDUCE TOTAL SUSPENDED SOLIDS, SHALL NOT OUTLET TO THE WETLANDS AND SHALL BE IN COMPLIANCE WITH STATE AND FEDERAL STANDARDS.
- 7. CONSTRUCTION OF THE BIORETENTION AREAS AND GRAVEL INFILTRATION SWALE/TRENCH SHALL BE OVERSEEN BY A BIORETENTION SPECIALIST, EXPERIENCED IN BIORETENTION AREAS AND GRAVEL INFILTRATION SWALES/TRENCHES.
- 8. THERE MAY BE ADDITIONAL BIORETENTION AND INFILTRATION SWALE/TRENCH CRITERIA FOUND IN THE ORDER OF CONDITIONS FROM THE CANTON CONSERVATION COMMISSION. THE CONTRACTOR SHALL HAVE A COPY OF THESE REQUIREMENTS PRIOR TO COMMENCING CONSTRUCTION, AND SHALL REVIEW, AND COMPLY WITH THE ORDER OF CONDITIONS AT NO ADDITIONAL COST TO THE OWNER.
- 9. DO NOT USE HEAVY EQUIPMENT WITHIN THE BIORETENTION AND INFILTRATION SWALE/TRENCH AREAS. HEAVY EQUIPMENT CAN BE USED AROUND THE PERIMETER, TO SUPPLY THE SOILS. GRADE WETLAND REPLICATION AREA WITH LIGHT EQUIPMENT SUCH AS A COMPACT LOADER OR DOZER WITH MARSH TRACK.
- 10. CONTRACTOR SHALL SUBMIT SEED & SOIL SHOP DRAWINGS FOR REVIEW AND APPROVAL TO ALLEN & MAJOR ASSOCIATES PRIOR TO ORDERING MATERIALS AND CONSTRUCTION.
- 11. CONTRACTOR PERFORMING BIORETENTION TO HAVE PRIOR BIORETENTION AND INFILTRATION SWALE/TRENCH CONSTRUCTION CONSTRUCTION EXPERIENCE AND QUALIFICATIONS NECESSARY TO PROVIDE A HIGH QUALITY BIORETENTION AREAS.
- 12. SEEDED & PLANTED AREAS TO BE TEMPORARILY IRRIGATED UNTIL ESTABLISHMENT AND ACCEPTANCE. CONTRACTOR RESPONSIBLE FOR RE-SEEDING AND REPLANTING AS NECESSARY AND MAINTENANCE UNTIL ESTABLISHMENT AND ACCEPTANCE.
- 13. PRIOR TO LAYING TOPSOIL, ALL SUBSOIL TO BE TILLED TO A DEPTH OF AT LEAST 12" TO REMOVE CONSTRUCTION COMPACTION AND ALLOW FOR PROPER DRAINAGE OF TOPSOILS.
- 14. ALL DISTURBED AREAS NOT OTHERWISE NOTED SHALL RECEIVE 6" OF SUITABLE LOAM & UPLAND SEED MIX. LAWNS WITH OVER 3:1 SLOPES SHALL BE PROTECTED WITH AN EROSION CONTROL BLANKET.

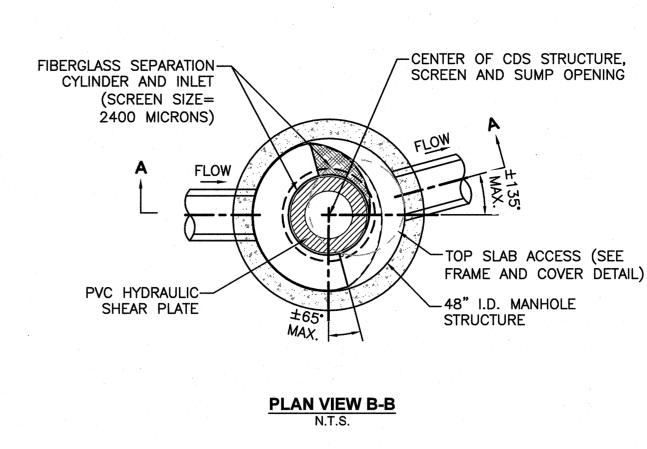

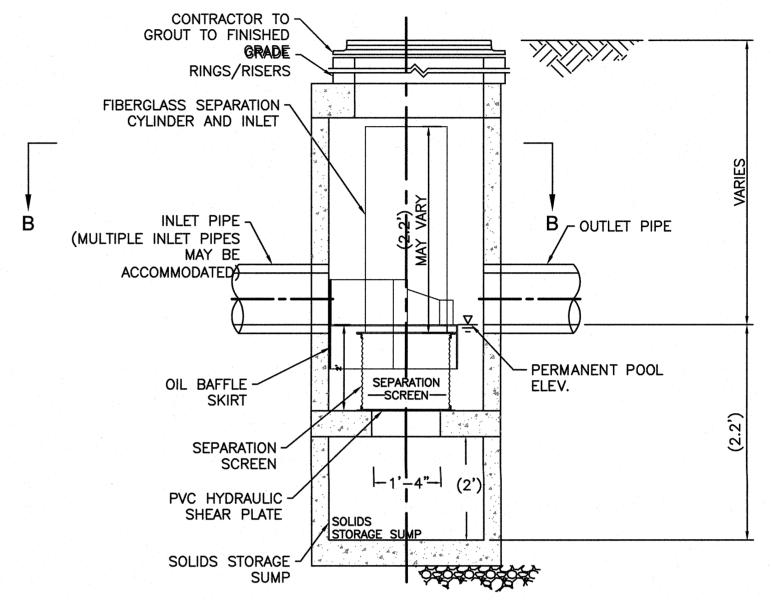

ELEVATION A-A

1. CONTECH TO PROVIDE ALL MATERIALS UNLESS NOTED OTHERWISE.
2. DIMENSIONS MARKED WITH () ARE REFERENCE DIMENSIONS. ACTUAL DIMENSIONS

- MAY VARY.

 3. FOR FABRICATION DRAWINGS WITH DETAILED STRUCTURE DIMENSIONS AND
- WEIGHTS, PLEASE CONTACT YOUR CONTECH CONSTRUCTION PRODUCTS
 REPRESENTATIVE. www.contech-cpi.com
- 4. CDS WATER QUALITY STRUCTURE SHALL BE IN ACCORDANCE WITH ALL DESIGN DATA AND INFORMATION CONTAINED IN THIS DRAWING.
- 5. STRUCTURE SHALL MEET AASHTO HS20 AND CASTINGS SHALL MEET AASHTO M306 LOAD RATING, ASSUMING GROUNDWATER ELEVATION AT, OR BELOW, THE OUTLET PIPE INVERT ELEVATION. ENGINEER OF RECORD TO CONFIRM
- ACTUAL GROUNDWATER ELEVATION.

 6. PVC HYDRAULIC SHEAR PLATE IS PLACED ON SHELF AT BOTTOM OF SCREEN CYLINDER. REMOVE AND REPLACE AS NECESSARY DURING MAINTENANCE CLEANING.
- INSTALLATION NOTES


 1. ANY SUB-BASE, BACKFILL DEPTH, AND/OR ANTI-FLOTATION PROVISIONS ARE
- SITE—SPECIFIC DESIGN CONSIDERATIONS AND SHALL BE SPECIFIED BY ENGINEER OF RECORD.
- 2. CONTRACTOR TO PROVIDE EQUIPMENT WITH SUFFICIENT LIFTING AND REACH CAPACITY TO LIFT AND SET THE CDS MANHOLE STRUCTURE (LIFTING
- CLUTCHES PROVIDED).

 3. CONTRACTOR TO ADD JOINT SEALANT BETWEEN ALL STRUCTURE SECTIONS.
- AND ASSEMBLE STRUCTURE.

 4. CONTRACTOR TO PROVIDE, INSTALL, AND GROUT PIPES. MATCH PIPE
- 5. CONTRACTOR TO TAKE APPROPRIATE MEASURES TO ASSURE UNIT IS WATER TIGHT, HOLDING WATER TO FLOWLINE INVERT MINIMUM. IT IS SUGGESTED THAT ALL JOINTS BELOW PIPE INVERTS ARE GROUTED.

HIGH EFFICIENCY CDS1515-3-C
(OR APPROVED EQUAL)

INVERTS WITH ELEVATIONS SHOWN.

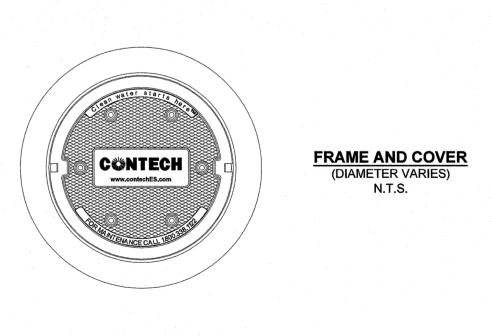

PROFESSIONAL ENGINEER FOR ALLEN & MAJOR ASSOCIATES, INC.

A 03-23-2022 REVISED PER COMMENTS
REV DATE DESCRIPTION

APPLICANT\OWNER:

SLV SCHOOL STREET, LLC

NEEDHAM, MA 02494
PROJECT:

THE SANCTUARY
SCHOOL STREET
MANCHESTER-BY-THE-SEA, MA

257 HILLSIDE AVENUE

 PROJECT NO.
 2725-01
 DATE:
 07-16-2021

 SCALE:
 AS SHOWN
 DWG. NAME:
 C-2725-01

DESIGNED BY: CMQ/SJL | CHECKED BY:



ASSOCIATES, INC.

civil engineering • land surveying
environmental consulting • landscape architecture
w w w . a l l e n m a j o r . c o m

100 COMMERCE WAY, SUITE 5

WOBURN MA 01801-8501

TEL: (781) 935-6889 FAX: (781) 935-2896

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